


TOWN OF WESTBROOK, CONNECTICUT

TOWN CENTER PARKING

IMPROVEMENT PLAN

PROJECT NO. 226692


SEPTEMBER 28, 2016

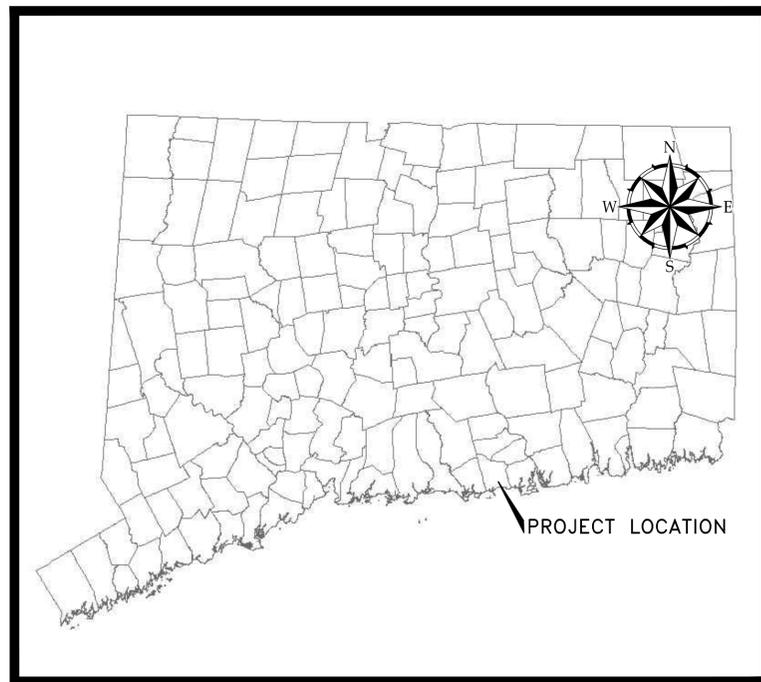

PROJECT LOCATION MAP

LIST OF DRAWINGS:

G-000	COVER SHEET	1 OF 12
G-001	GENERAL NOTES AND LEGEND	2 OF 12
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C-200	LAYOUT AND MATERIALS PLAN	4 OF 12
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C-202	ROUTE 153 LAYOUT AND MATERIALS PLAN	6 OF 12
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C-301	SITE DETAILS 2	8 OF 12
C-302	SITE DETAILS 3	9 OF 12
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E-002	ELECTRICAL SITE PLAN	11 OF 12
E-003	ELECTRICAL LIGHTING, POWER PLAN, DETAILS, AND SCHEDULE	12 OF 12

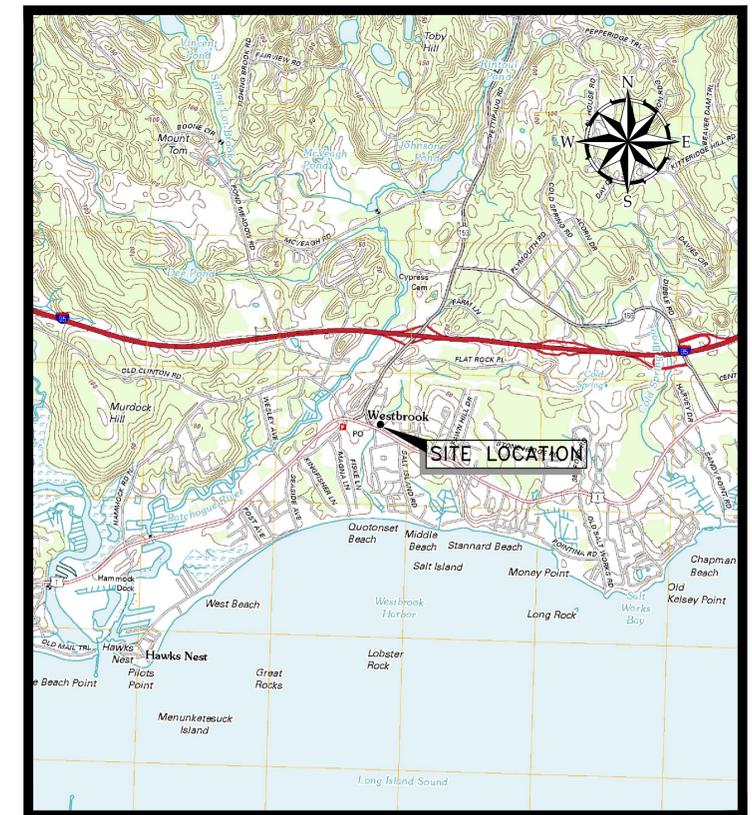

SOURCE: USGS TOPOGRAPHIC MAP

SITE LOCATION MAP

NOT TO SCALE




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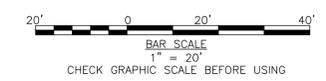


ISSUED FOR BID



- TREELINE (TYP.)
- ELECTRICAL SERVICE PEDESTAL (SEE SHEET E-002)
- BOLLARD (TYP.)
- 4" WHITE PAVEMENT MARKING (TYP.)
- MEET AND MATCH EXISTING GRADE
- 6"-0" PCC TRANSITION CURB
- SIGN R1-1, SIGN R3-2
- 12" STOP BAR WHITE PAINTED "STOP" (TYP.)
- SIGN R5-1

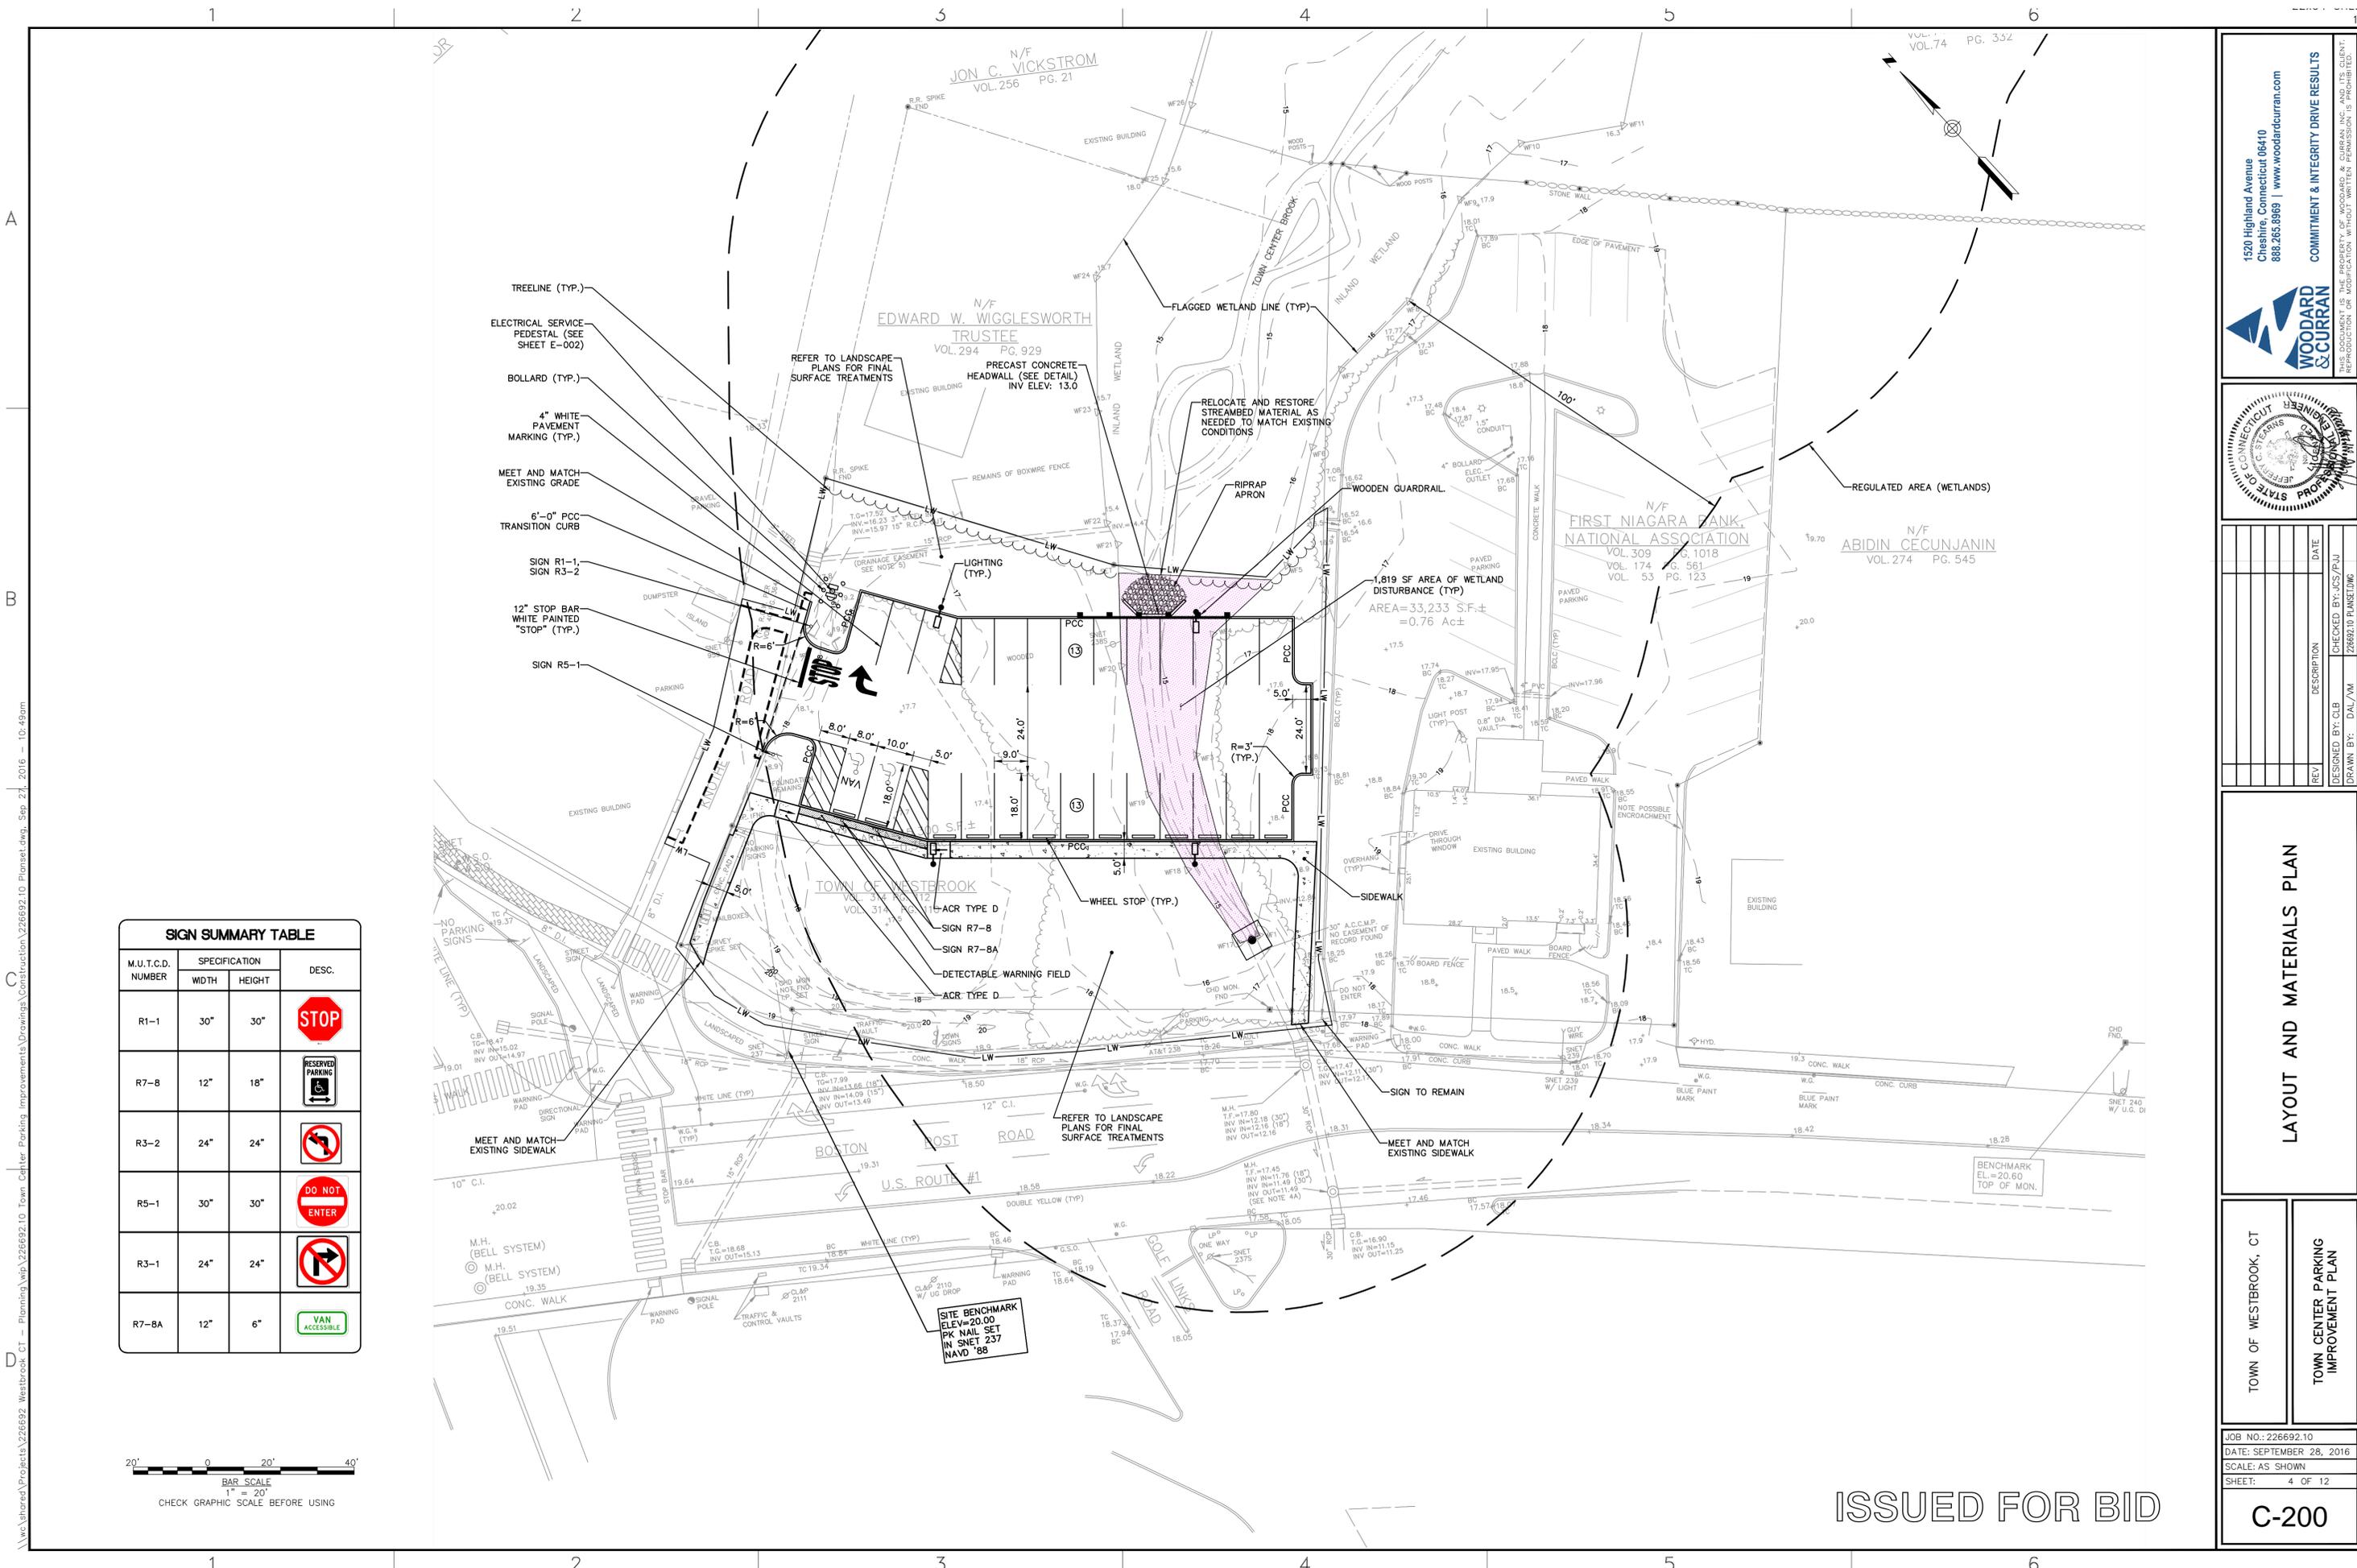SIGN SUMMARY TABLE			
M.U.T.C.D. NUMBER	SPECIFICATION		DESC.
	WIDTH	HEIGHT	
R1-1	30"	30"	
R7-8	12"	18"	
R3-2	24"	24"	
R5-1	30"	30"	
R3-1	24"	24"	
R7-8A	12"	6"	




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REV.	DESCRIPTION	DATE

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 DESIGNED BY: CLB
 DRAWN BY: DAL/WM

LAYOUT AND MATERIALS PLAN




TOWN OF WESTBROOK, CT

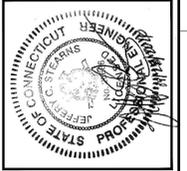TOWN CENTER PARKING IMPROVEMENT PLAN

JOB NO.: 226692.10
 DATE: SEPTEMBER 28, 2016
 SCALE: AS SHOWN
 SHEET: 4 OF 12


C-200

ISSUED FOR BID

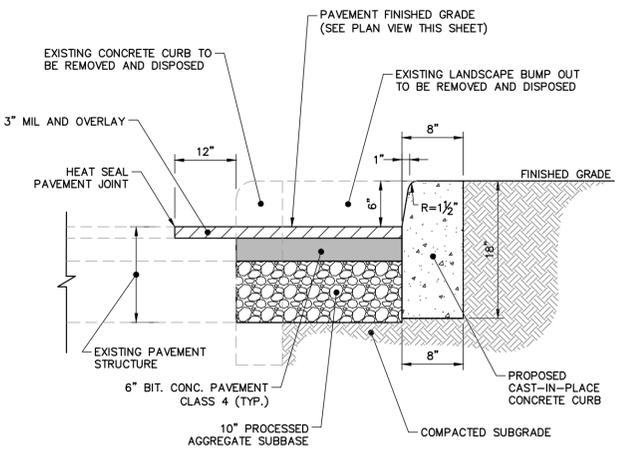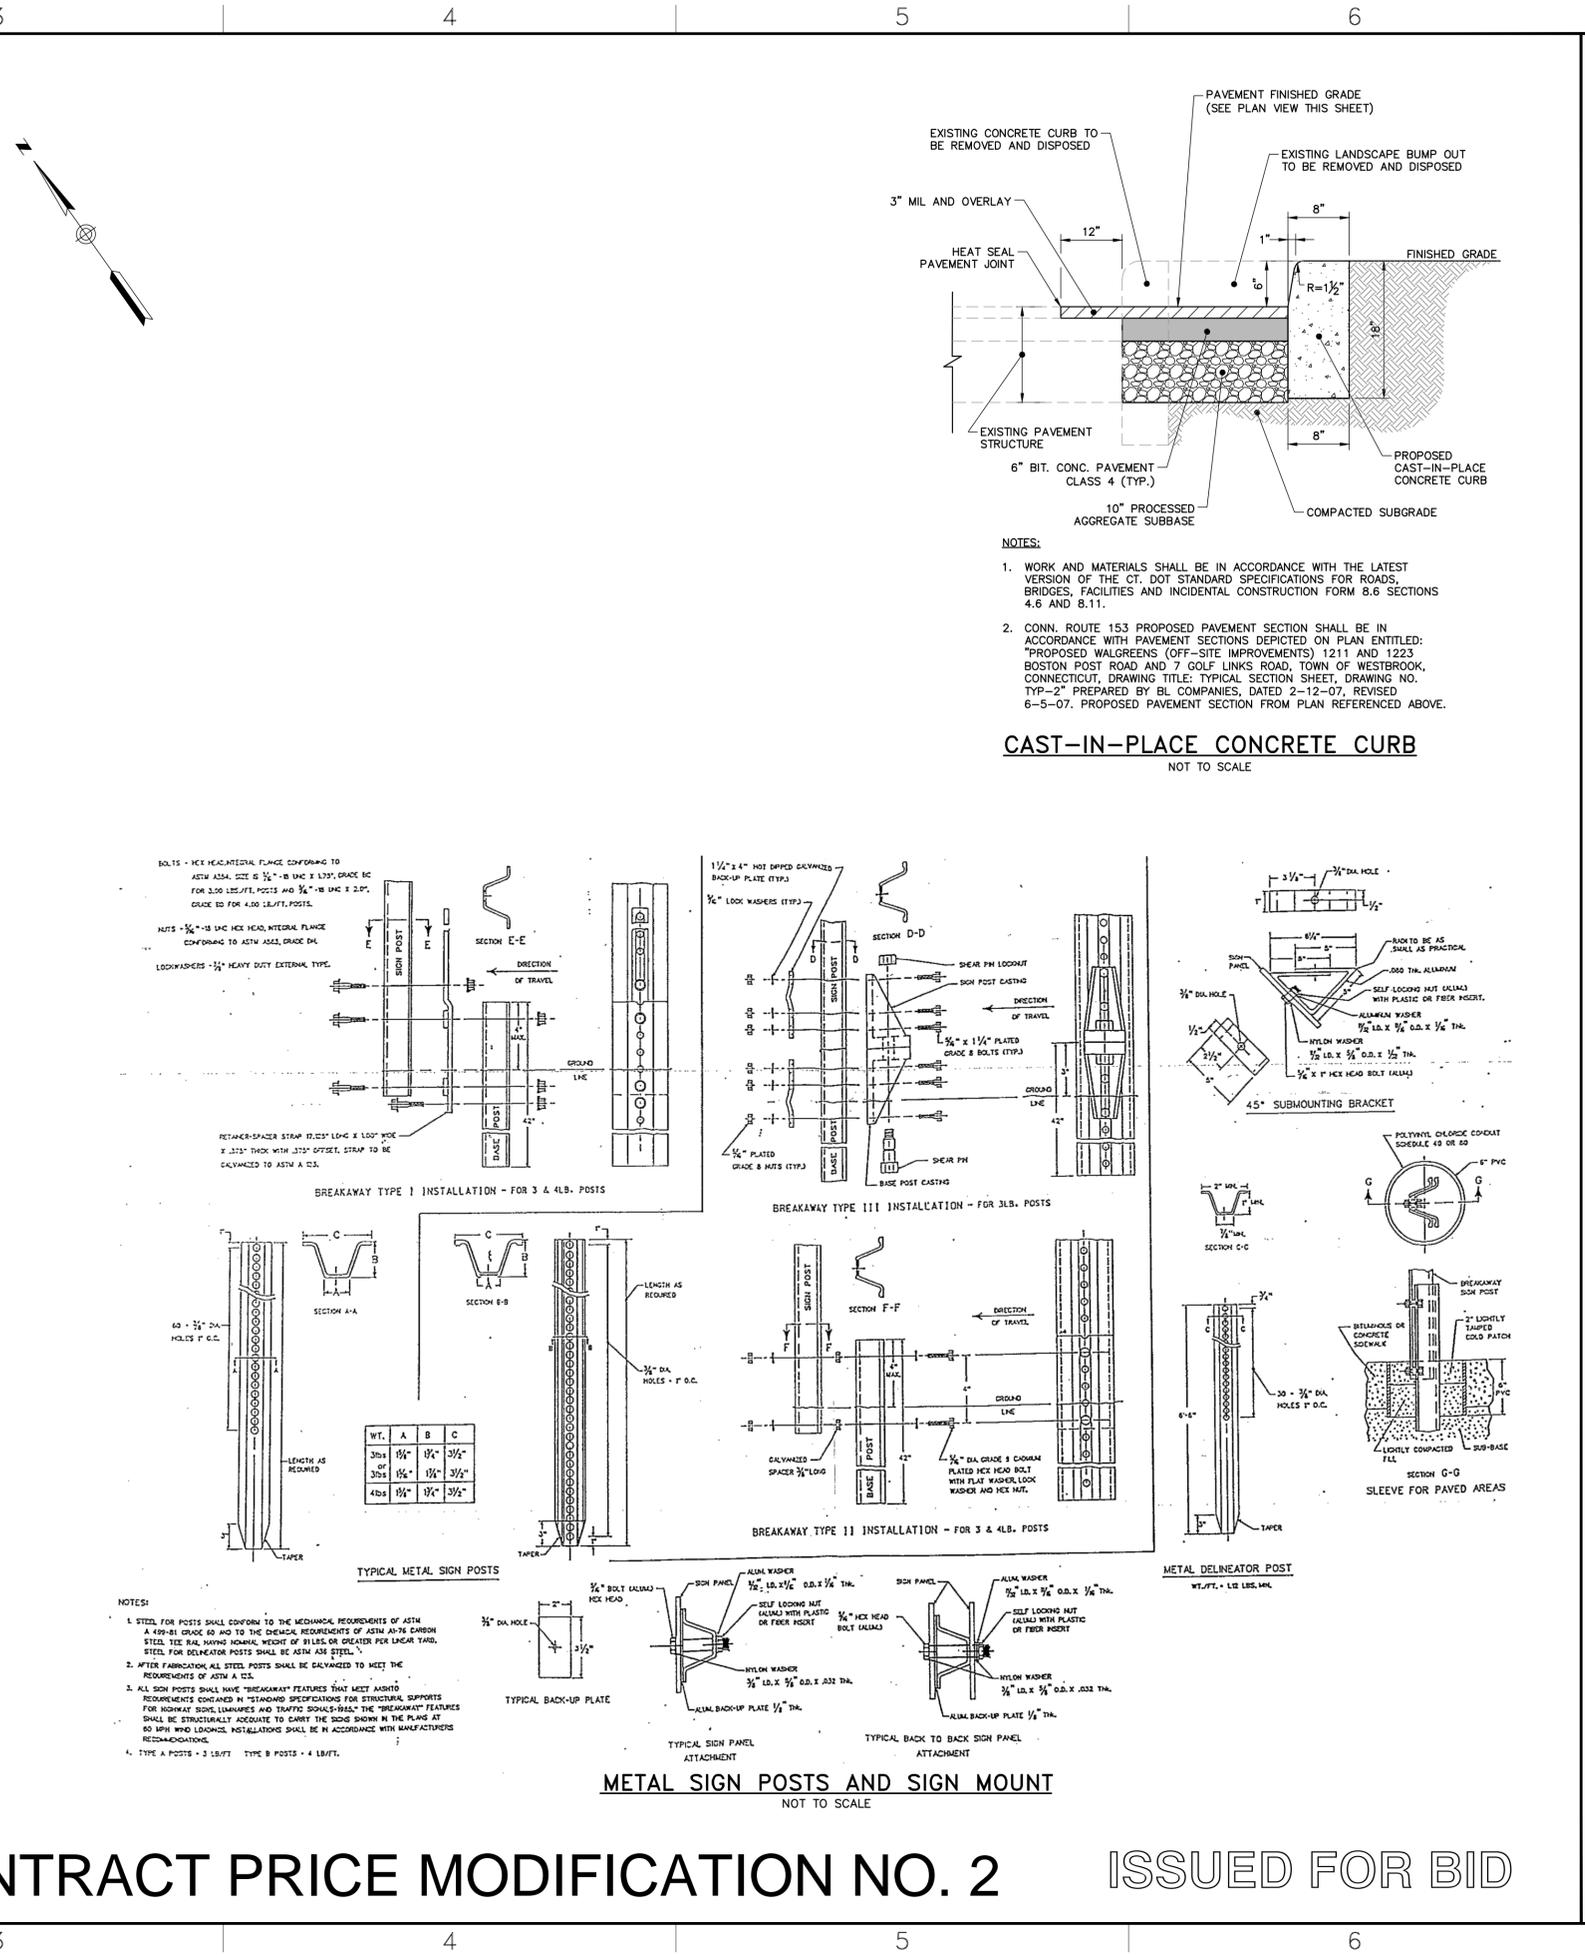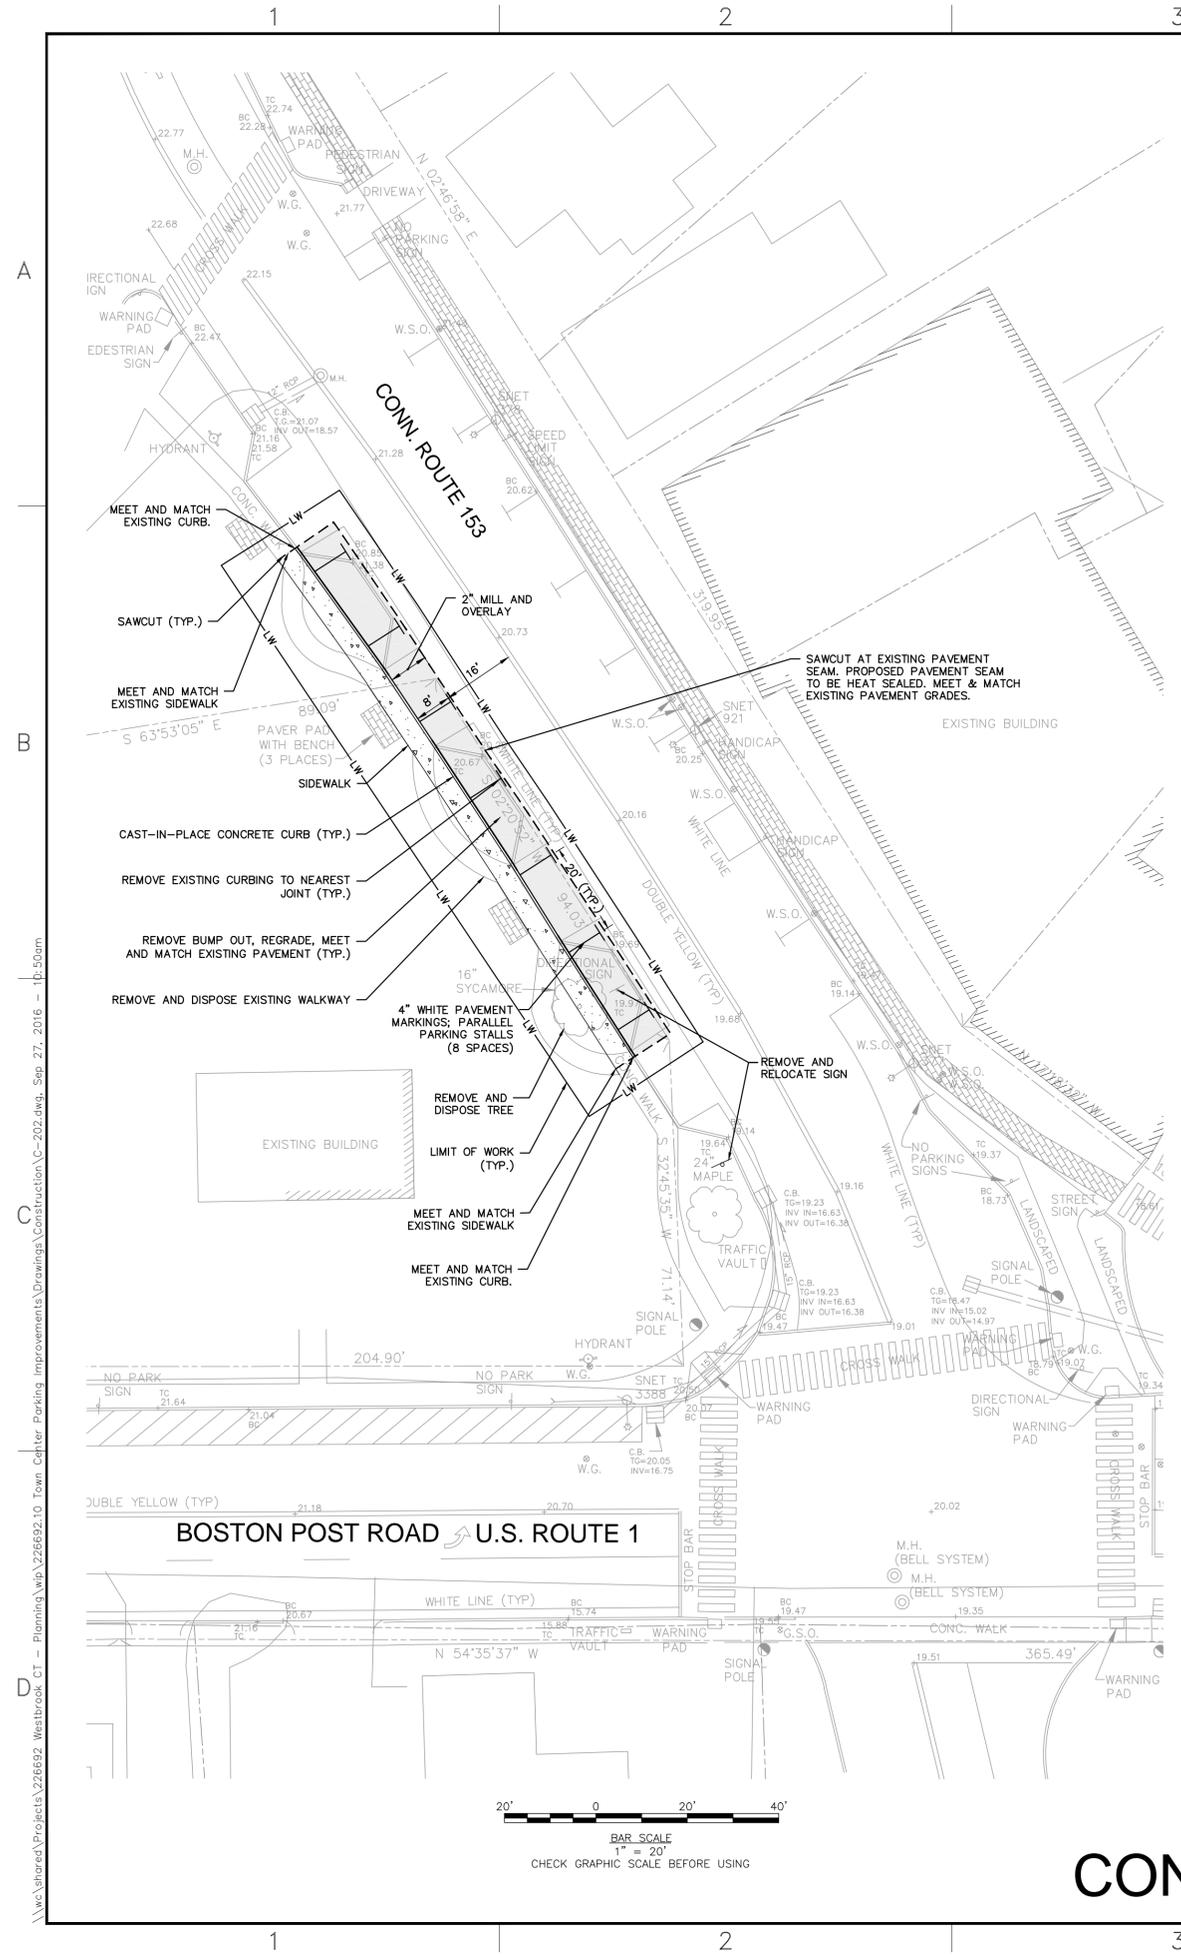

- NOTES:**
1. WORK AND MATERIALS SHALL BE IN ACCORDANCE WITH THE LATEST VERSION OF THE CT. DOT STANDARD SPECIFICATIONS FOR ROADS, BRIDGES, FACILITIES AND INCIDENTAL CONSTRUCTION FORM 8.6 SECTIONS 4.6 AND 8.11.
 2. CONN. ROUTE 153 PROPOSED PAVEMENT SECTION SHALL BE IN ACCORDANCE WITH PAVEMENT SECTIONS DEPICTED ON PLAN ENTITLED: "PROPOSED WALGREENS (OFF-SITE IMPROVEMENTS) 1211 AND 1223 BOSTON POST ROAD AND 7 GOLF LINKS ROAD, TOWN OF WESTBROOK, CONNECTICUT, DRAWING TITLE: TYPICAL SECTION SHEET, DRAWING NO. TYP-2" PREPARED BY BL COMPANIES, DATED 2-12-07, REVISED 6-5-07. PROPOSED PAVEMENT SECTION FROM PLAN REFERENCED ABOVE.

CAST-IN-PLACE CONCRETE CURB
NOT TO SCALE

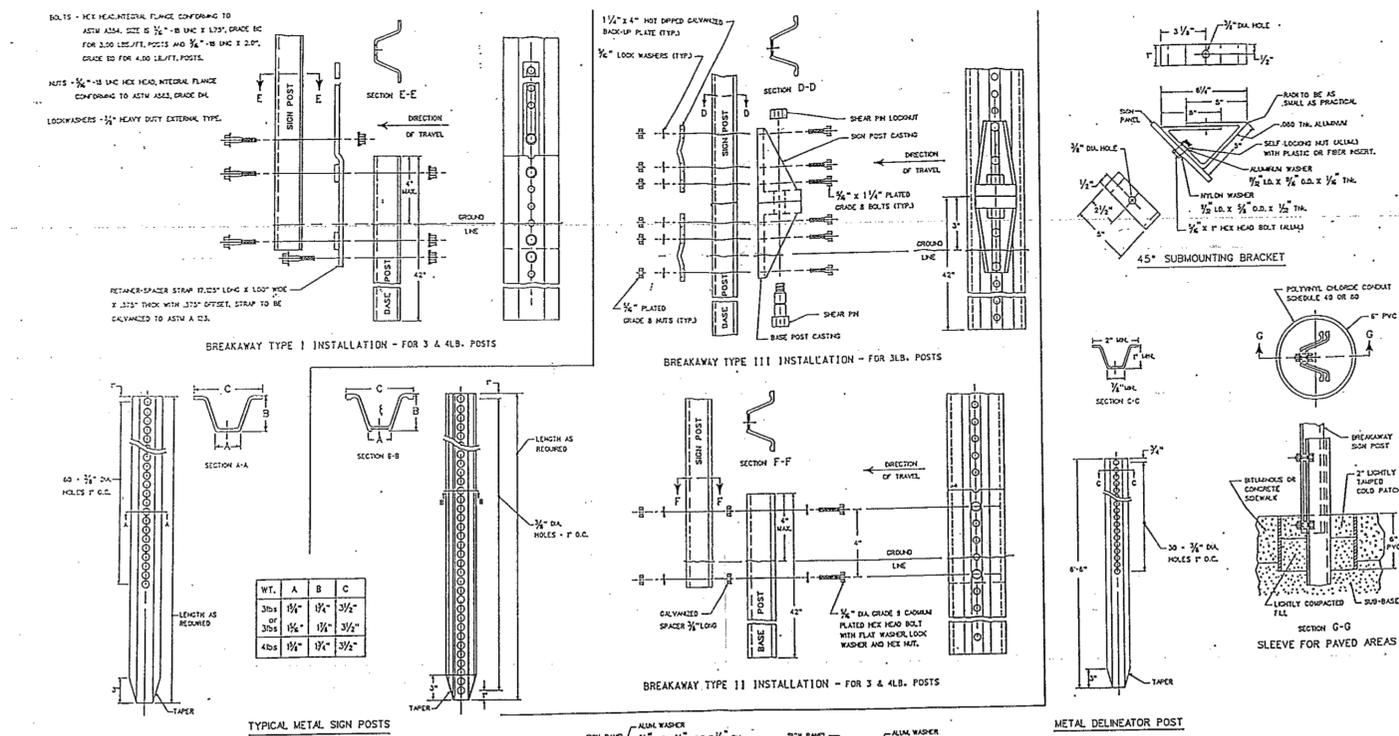

- NOTES:**
1. STEEL FOR POSTS SHALL CONFORM TO THE MECHANICAL REQUIREMENTS OF ASTM A 36 OR A 570 GRADE 50 AND TO THE CHEMICAL REQUIREMENTS OF ASTM A 36 OR A 570 GRADE 50. STEEL FOR DELINEATOR POSTS SHALL BE ASTM A 570 STEEL.
 2. AFTER FABRICATION ALL STEEL POSTS SHALL BE GALVANIZED TO MEET THE REQUIREMENTS OF ASTM A 123.
 3. ALL SIGN POSTS SHALL HAVE "BREAKAWAY" FEATURES THAT MEET ASTM REQUIREMENTS FOR SIGN POSTS. "BREAKAWAY" FEATURES SHALL BE STRUCTURALLY ACCURATE TO CARRY THE SIGNS SHOWN IN THE PLAN AT 80 MPH WIND LOADS. INSTALLATIONS SHALL BE IN ACCORDANCE WITH MANUFACTURERS RECOMMENDATIONS.
 4. TYPE A POSTS - 3 LB/FT. TYPE B POSTS - 4 LB/FT.

METAL SIGN POSTS AND SIGN MOUNT
NOT TO SCALE

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REGISTERED PROFESSIONAL ENGINEER
C. STEPHEN WOODARD
No. 10000
EXPIRES 12/31/2018

REV.	DESCRIPTION	DATE


CHECKED BY: JCS/PJU
DESIGNED BY: CLB
DRAWN BY: DAL/VM
C-202.DWG

ROUTE 153 LAYOUT AND MATERIALS PLAN


TOWN OF WESTBROOK, CT
TOWN CENTER PARKING IMPROVEMENT PLAN

JOB NO.: 226692.10
DATE: SEPTEMBER 28, 2016
SCALE: AS SHOWN
SHEET: 6 OF 12

C-202

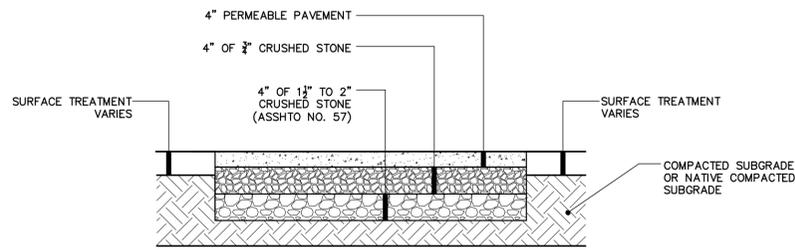


PERMEABLE PAVEMENT DETAIL
NOT TO SCALE

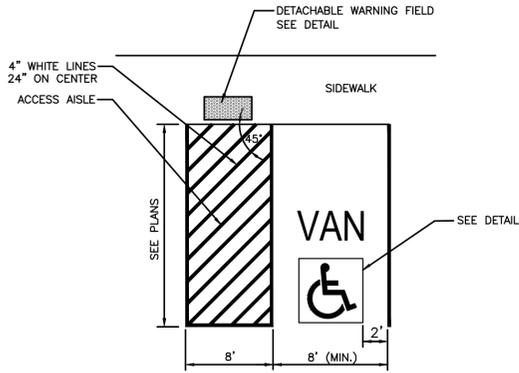


- NOTES:**
1. ALL DIMENSIONS TO EDGES OF 4" PAVEMENT STRIPING.
 2. ALL STRIPING SHALL BE 4" WIDE SOLID WHITE PAVEMENT MARKINGS UNLESS OTHERWISE NOTED.
 3. 9' STALL WIDTH REFERS TO 9' MIN. CLEAR BETWEEN INSIDE EDGES OF PAVEMENT MARKINGS.
 4. MAXIMUM ALLOWABLE CURB RAMP AND SIDEWALK CROSS SLOPES SHALL BE 1.5% (1% MIN)

HANDICAPPED PARKING STALL
NOT TO SCALE

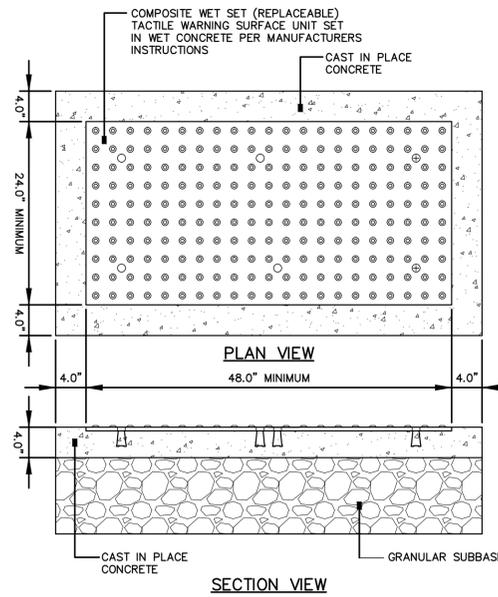


CURB RAMP DETECTABLE WARNING FIELD
NOT TO SCALE

- NOTES:**
1. COMPOSITE WET SET (REPLACEABLE) TACTILE WARNING SURFACE UNITS SHALL BE AS MANUFACTURED BY ADA SOLUTIONS, INC. (WWW.ADATILE.COM), OR APPROVED EQUAL.
 2. CAST IN PLACE CONCRETE SHALL MEET SPECIFICATIONS FOR CONNDOT CLASS A STRUCTURAL CONCRETE, MINIMUM COMPRESSIVE STRENGTH 4,000 PSI. THE CONCRETE SHALL BE SEALED PRIOR TO SETTING PANELS. THE EXPOSED CONCRETE BORDER SHALL RECEIVE A GROOVED EDGE BETWEEN THE TILE AND CONCRETE, ALONG WITH A UNIFORM BROOM FINISH PERPENDICULAR TO THE FLOW OF PEDESTRIAN TRAFFIC.
 3. TRUNCATED DOMES SHALL BE ALIGNED IN ROWS, PARALLEL AND PERPENDICULAR TO THE PREDOMINANT DIRECTION OF TRAVEL. TRUNCATED DOME BRICKS AND GRANITE PAVERS ARE NOT ALLOWED.
 4. FOR ALL SIDEWALK RAMP MADE OF CONCRETE OR ASPHALT, BRICK RED COLORED TILES SHALL BE USED. FOLLOW MANUFACTURER'S INSTRUCTIONS FOR INSTALLATION.

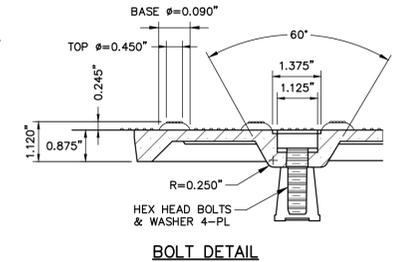


BOLT DETAIL

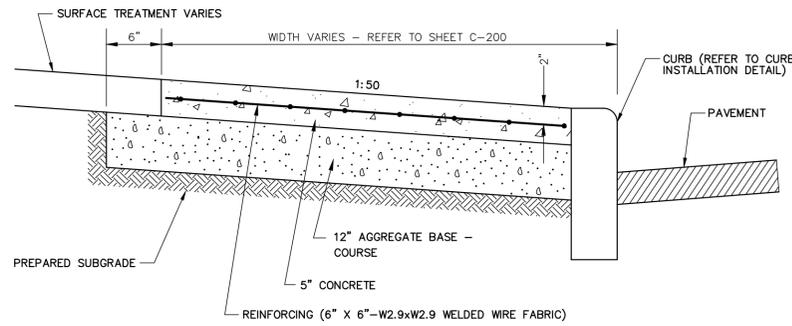


SIDEWALK DETAIL
NOT TO SCALE


NOTE:
PROVIDE SEALED EXPANSION JOINTS WHERE INDICATED AT 20 FEET ON CENTER AND AS SPECIFIED ON THE DRAWINGS

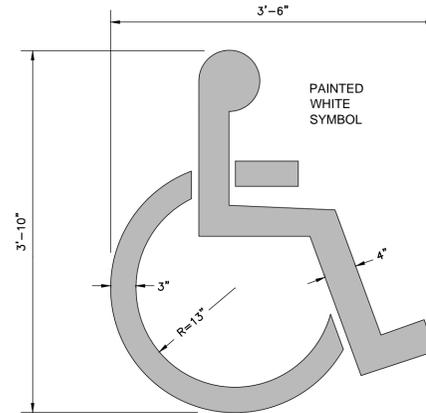

TYPICAL PAINTED HANDICAP SYMBOL DETAIL
NOT TO SCALE

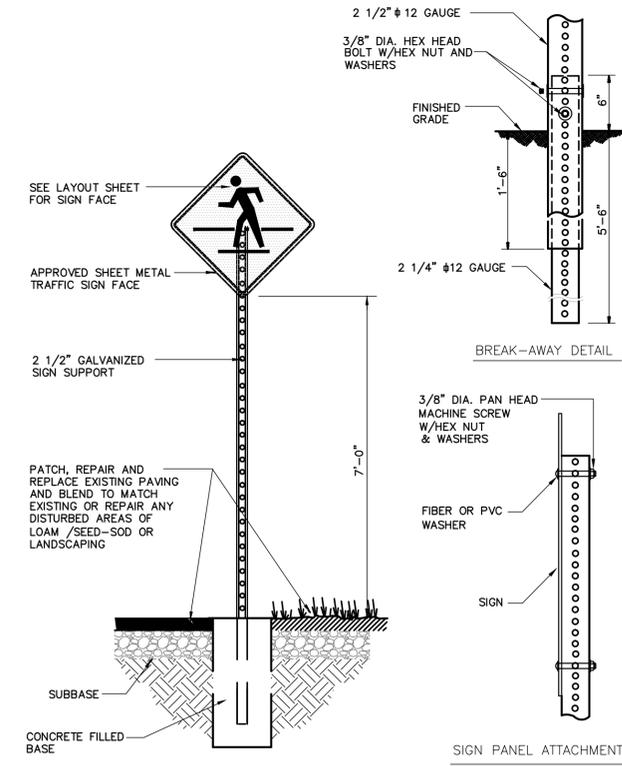


TRAFFIC SIGN POST
NOT TO SCALE

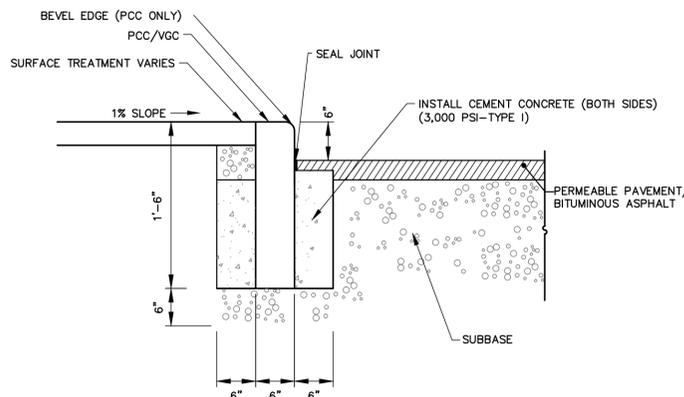

- NOTES:**
1. PROVIDE SMOOTH TROWEL OR HAIR BRUSH FINISH TO ALL EXPOSED SURFACES.
 2. VERTICAL GRANITE CURB MAY BE USED WITH APPROVAL BY THE TOWN. (ALTERNATE NO. 1).
 - 2A. VERTICAL GRANITE CURBING SIZE SHALL MEET THE SIZE SHOWN ABOVE (18" HEIGHT MAY BE USED).
 - 2B. STRAIGHT SECTIONS SHALL NOT BE USED FOR RADI LESS THAN 100'.
 - 2C. CURBING SECTIONS SHALL BE PINNED TOGETHER.

PRECAST CONCRETE CURB (PCC)
NOT TO SCALE

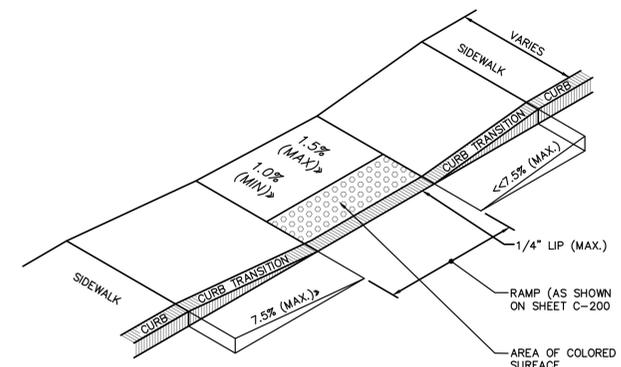


ACCESSIBLE CURB RAMP NOTES:

1. THE MAXIMUM ALLOWABLE SIDEWALK AND CURB RAMP CROSS SLOPES SHALL BE 1.5% (1% MIN.).
2. THE MAXIMUM ALLOWABLE SLOPE OF ACCESSIBLE ROUTE EXCLUDING CURB RAMP SHALL BE 5%.
3. THE MAXIMUM ALLOWABLE SLOPE OF ACCESSIBLE ROUTE CURB RAMP SHALL BE 7.5%.
4. A MINIMUM OF 3 FEET CLEAR SHALL BE MAINTAINED AT ANY PERMANENT OBSTACLE IN ACCESSIBLE ROUTE (I.E., HYDRANTS, UTILITY POLES, TREE WELLS, SIGNS, ETC.)
5. CURB TREATMENT VARIES. SEE PLANS FOR CURB TYPE.
6. BASE OF RAMP SHALL BE GRADED TO PREVENT PONDING.
7. SEE TYPICAL SIDEWALK SECTION FOR RAMP CONSTRUCTION.
8. WHERE ACCESSIBLE ROUTES ARE LESS THAN 5' IN WIDTH (EXCLUDING CURBING) A 5' x 5' PASSING AREA SHALL BE PROVIDED AT INTERVALS NOT TO EXCEED 200 FEET.
9. ELIMINATE ALL CURBING AT RAMP (OTHER THAN VERTICAL CURBING, WHICH SHALL BE SET FLUSH) WHERE IT ABUTS ROADWAY.
10. DETECTABLE WARNING SHALL CONTRAST VISUALLY WITH ADJOINING SURFACES.
11. TRUNCATED DOMES AND ALL RELATED INSTALLED SURFACES TO BE INSTALLED ACCORDING TO MANUFACTURERS SPECIFICATIONS. ALL DETECTABLE WARNING SURFACE INSTALLATIONS SHALL BE AT MINIMUM, AT LEAST AS NON SKID AS THE SURROUNDING PEDESTRIAN SURFACES.

ACCESSIBLE CURB RAMP (ACR) - TYPE D
NOT TO SCALE

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SITE DETAILS-1


TOWN OF WESTBROOK, CT

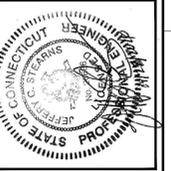TOWN CENTER PARKING
IMPROVEMENT PLAN

JOB NO.: 226692.10
DATE: SEPTEMBER 28, 2016
SCALE: AS SHOWN
SHEET: 7 OF 12

C-300


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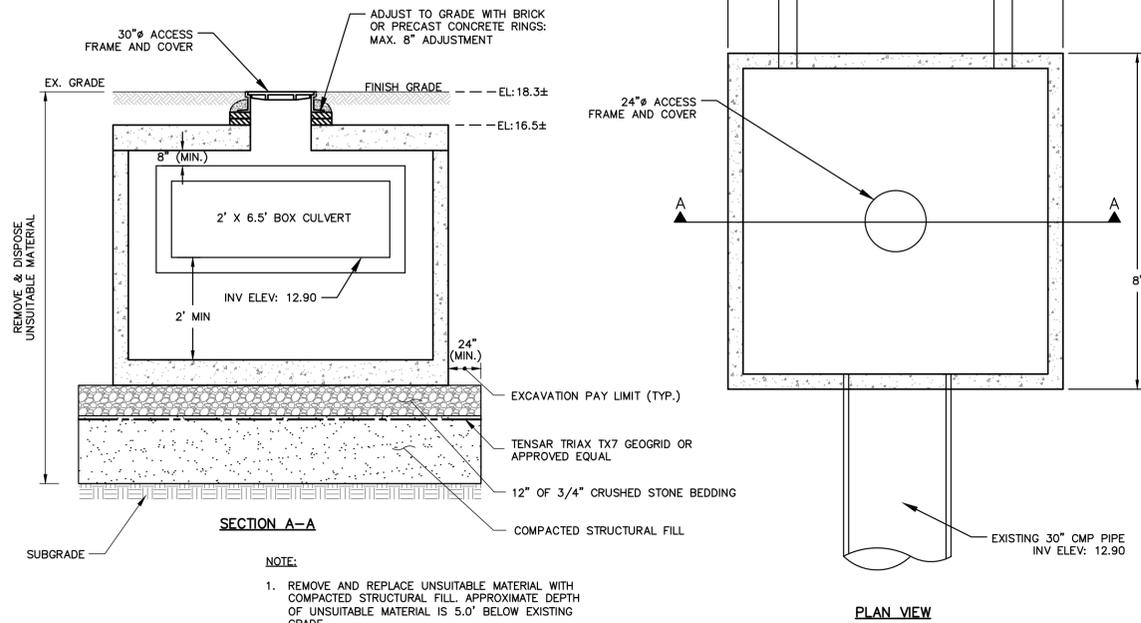
PRECAST CATCH BASIN TOP
(TYPE AS REQUIRED - TYPE "CL" SHOWN)

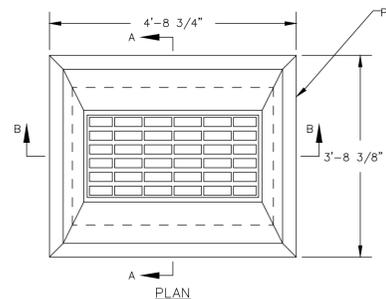NOTES:


1. IN PRECAST RISER SECTIONS, THE KNOCKOUTS OR OPENINGS AROUND THE PIPES SHALL BE MORTARED TO 6".
2. PRECAST REDUCER SHALL BE SPECIFICALLY SIZED & PLACED FOR THE TYPE OF TOP USED.
3. PLACE ALL PRECAST UNITS, TOPS AND CONCRETE BLOCKS IN A CEMENT MORTAR BED.
4. PRECAST UNITS SHALL BE REINFORCED WITH WELDED WIRE FABRIC.



PRECAST CONCRETE CATCH BASIN
NOT TO SCALE

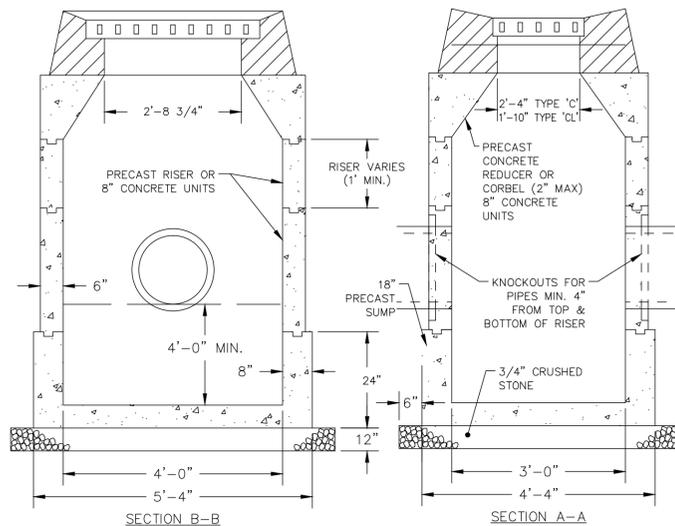


TRANSITION STRUCTURE
NOT TO SCALE

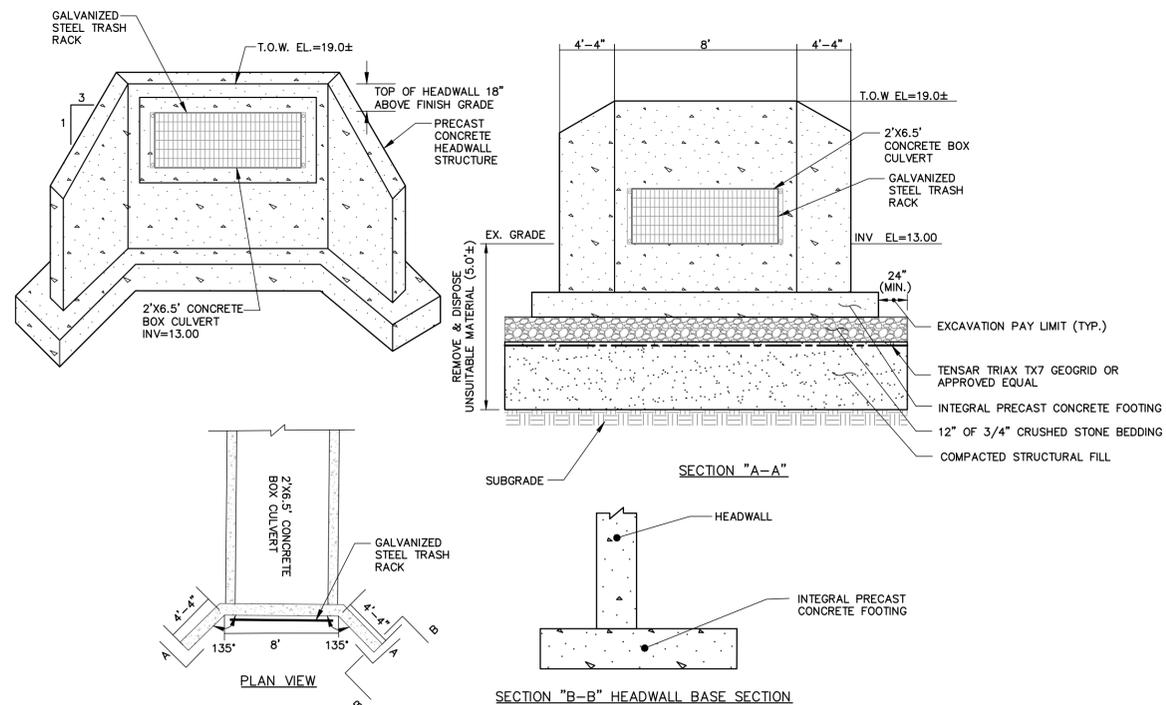


CONCRETE HEADWALL
NOT TO SCALE

PIPE SIZE	PATTERN NUMBER *
15"	2564
18"	2565
21"	2566
24"	2568A
30" & LARGER	CONSULT MANUF.

* CAMPBELL FOUNDRY CO. PATTERN NUMBERS

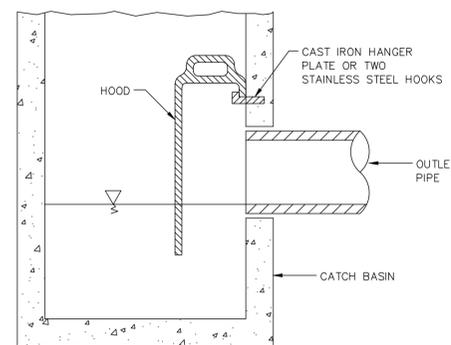

CATCH BASIN HOOD
NOT TO SCALE

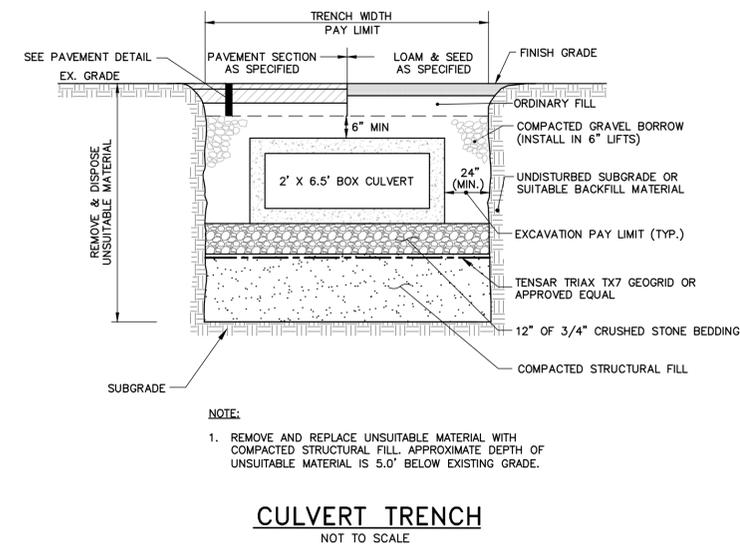

CULVERT TRENCH
NOT TO SCALE

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STATE OF CONNECTICUT
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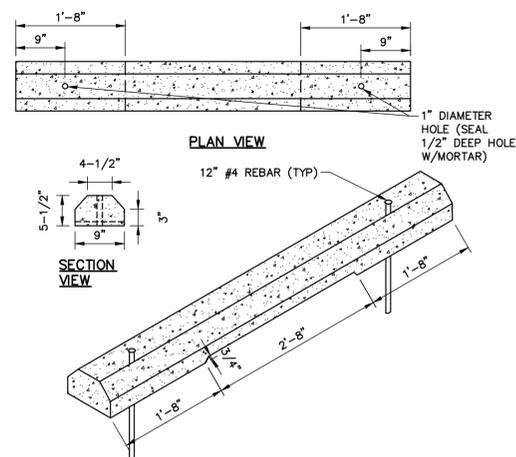
TOWN OF WESTBROOK, CT

TOWN CENTER PARKING IMPROVEMENT PLAN


JOB NO.: 226692.10
DATE: SEPTEMBER 28, 2016
SCALE: AS SHOWN
SHEET: 8 OF 12

C-301


ISSUED FOR BID




WHEEL STOP
NOT TO SCALE

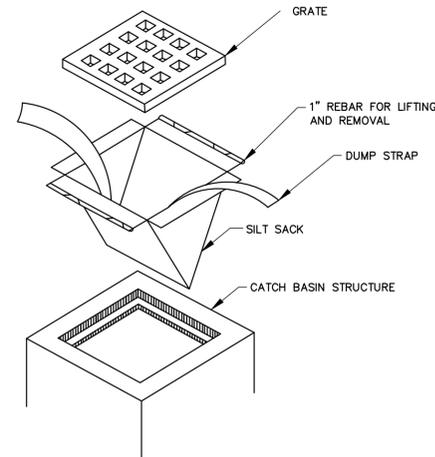

SILTSACK INLET
NOT TO SCALE

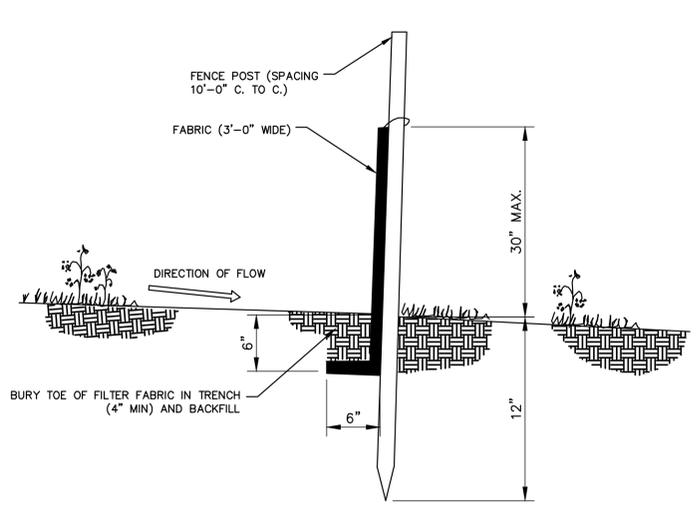


SILT FENCE
NOT TO SCALE

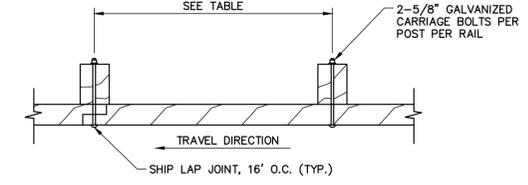


WOOD GUARDRAIL (NON-PEDESTRIAN)
NOT TO SCALE


POST SPACING	RADIUS
4'	20'-40'
5'-4"	40'-80'
8'	>80'

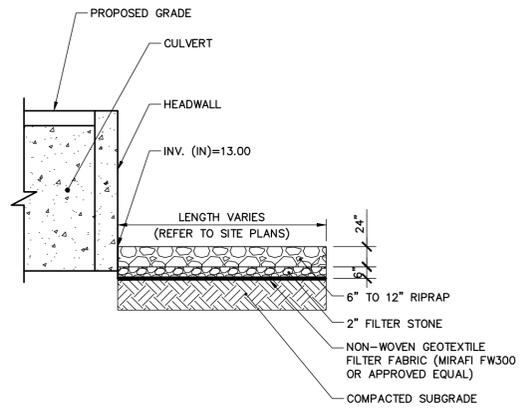


RIPRAP APRON PROTECTION
N.T.S.

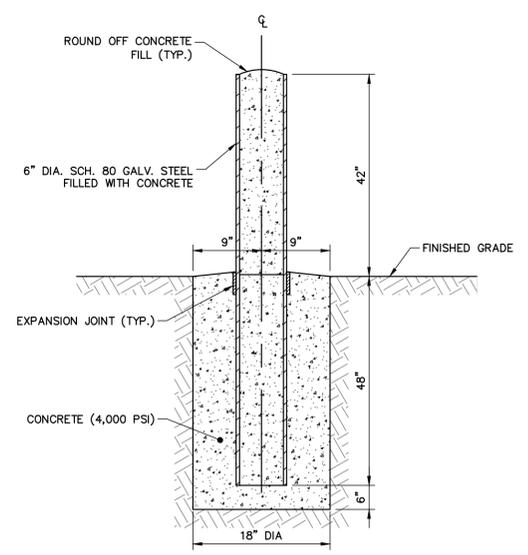

6" DIA. BOLLARD
NOT TO SCALE

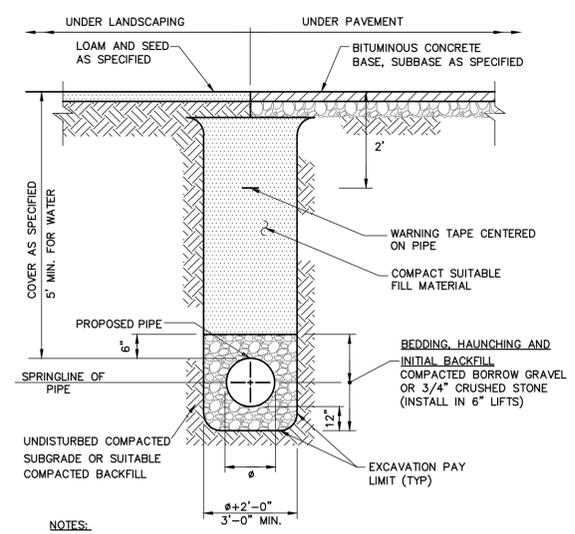


TYPICAL TRENCH
NOT TO SCALE

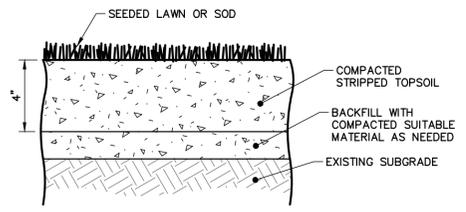

SEEDED OR SODDED LAWN
NOT TO SCALE

- NOTES:
- TOP OF LOAM (TOPSOIL) IS FINISHED GRADE.
 - TOPSOIL SHALL BE FERTILE, FRIABLE SOIL, TYPICAL OF PRODUCT SOILS IN THE SURROUNDING AREA AND SHALL CONTAIN BETWEEN 5% AND 12% ORGANIC MATTER AND SHALL HAVE A MAXIMUM STONE SIZE OF 1" AND SHALL CONFORM TO THE FOLLOWING GRADATION:

SIEVE	% PASSING
1"	100
NO. 4	85-100
NO. 40	60-85
NO. 100	38-60
NO. 200	28-40

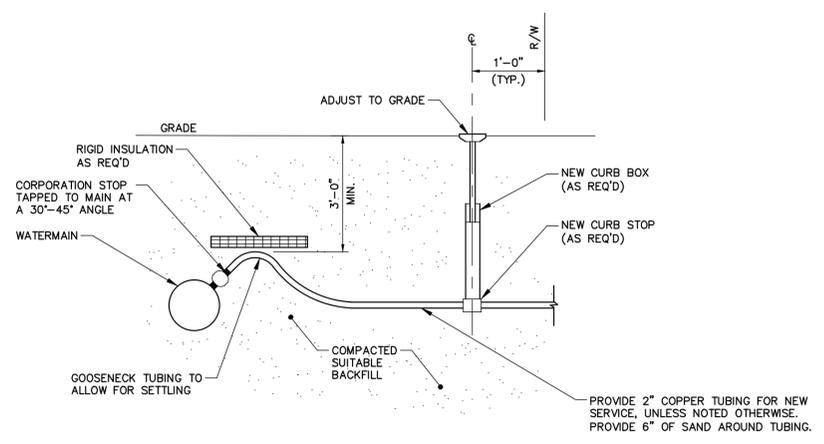

TYPICAL WATER SERVICE
NOT TO SCALE

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STATE OF CONNECTICUT
NO. 10000
JCS/R/J

REV	DESCRIPTION	DATE

DESIGNED BY: CLB
CHECKED BY: JCS/R/J
DRAWN BY: DAL/NFC/AM C-302 DETAILS

SITE DETAILS-3

TOWN OF WESTBROOK, CT


TOWN CENTER PARKING
IMPROVEMENT PLAN

JOB NO.: 226692.10
DATE: SEPTEMBER 28, 2016
SCALE: AS SHOWN
SHEET: 9 OF 12


C-302

ISSUED FOR BID


GENERAL

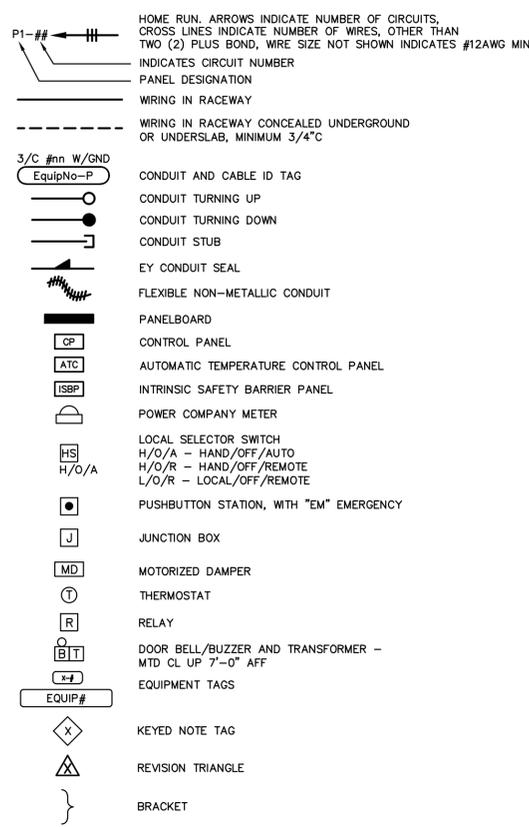


POWER

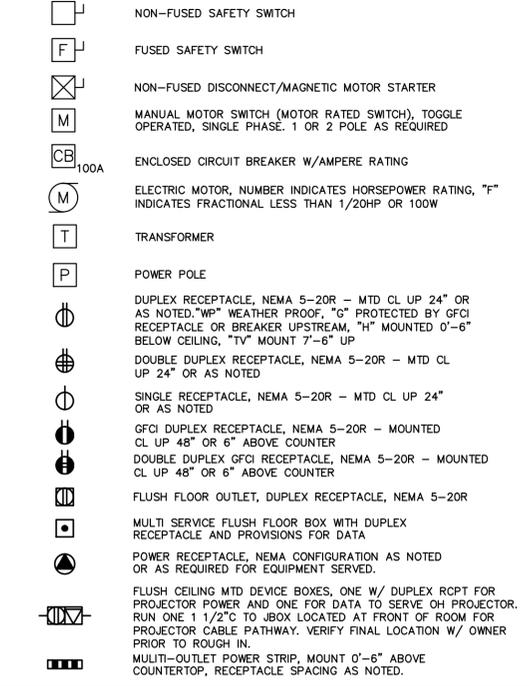


MISCELLANEOUS

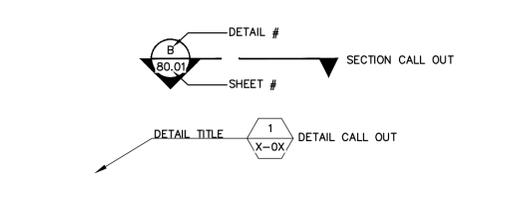


LIGHTING

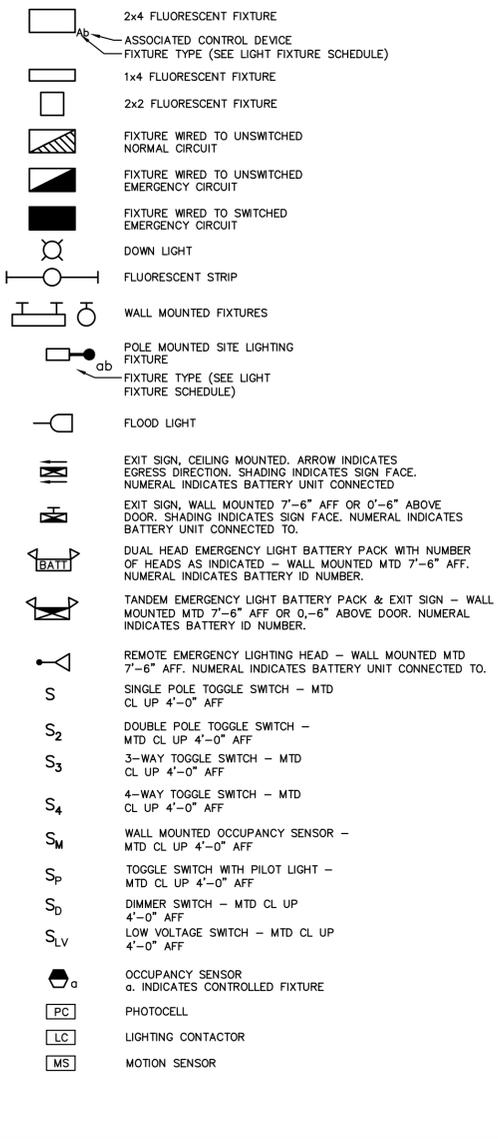


FIRE ALARM DIAGRAM SYMBOLS

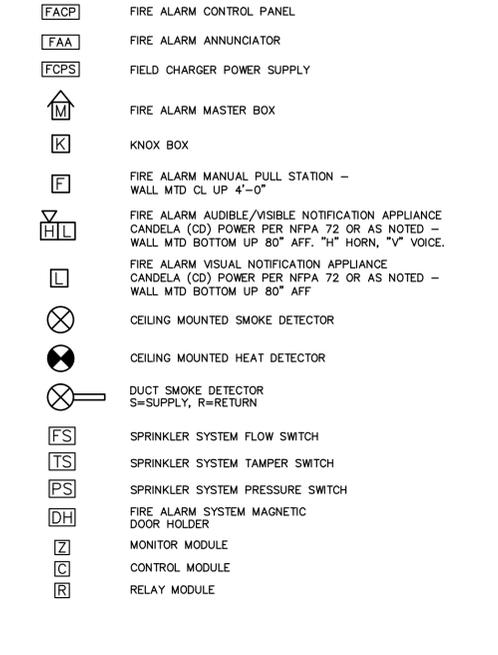


COMMUNICATIONS

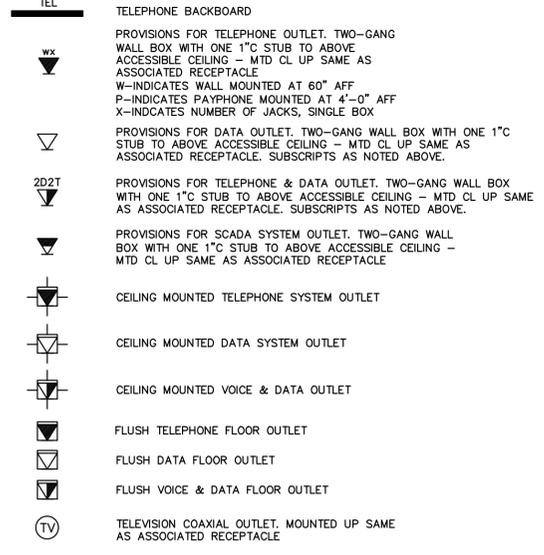


SECURITY

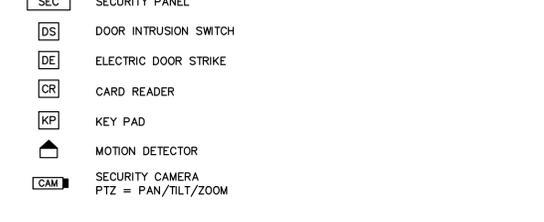


INTERCOM & PAGING SYSTEM

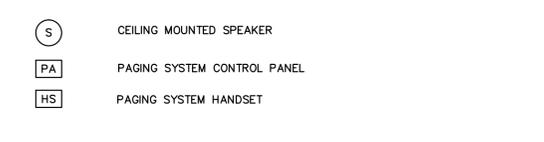


INSTRUMENTATION

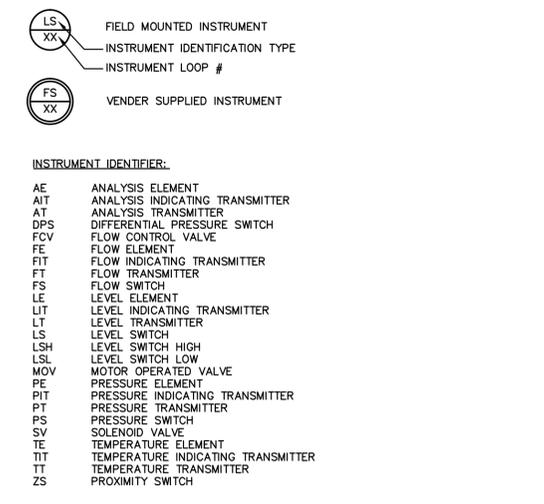

MISC TERMINALS

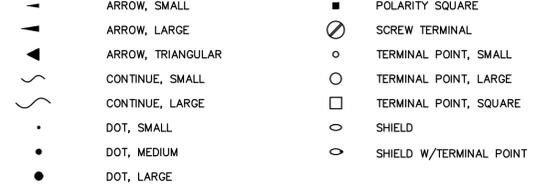


ONE-LINE DIAGRAM SYMBOLS

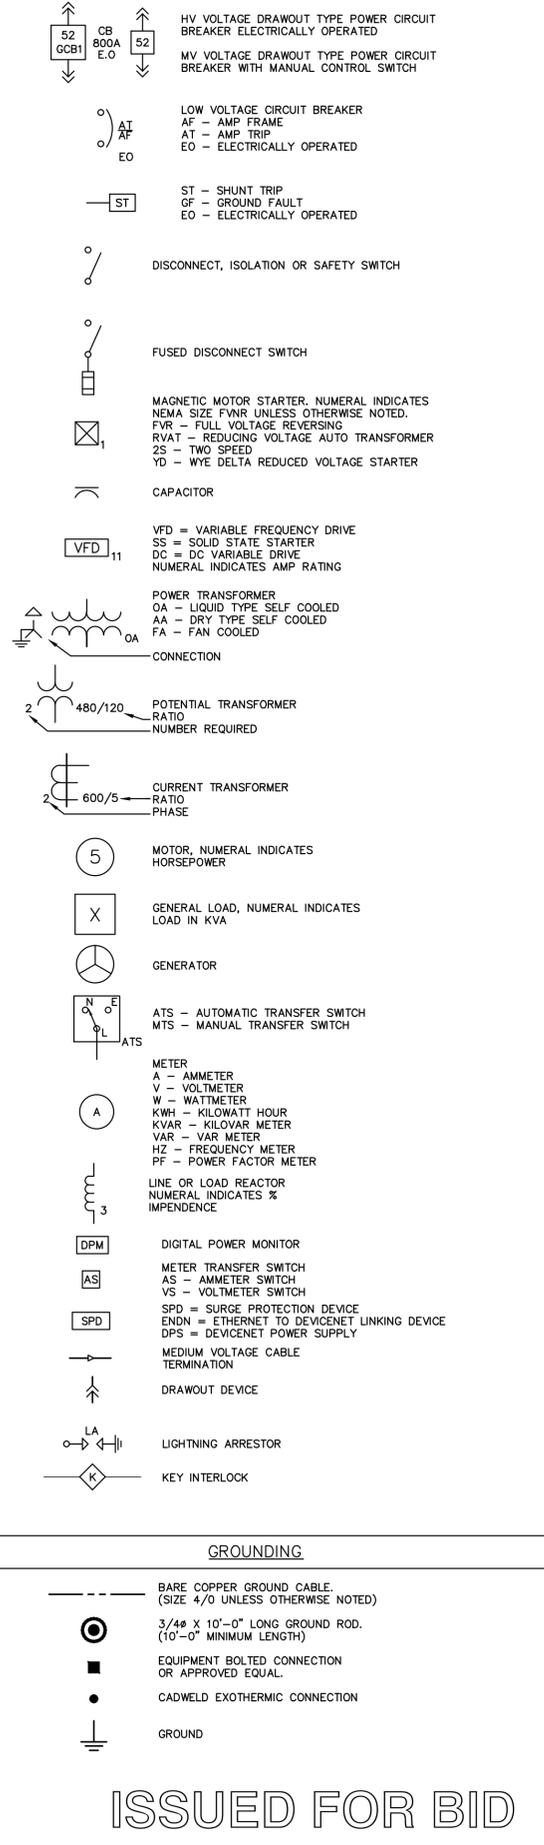

GROUNDING

CONTROL DIAGRAM SYMBOLS

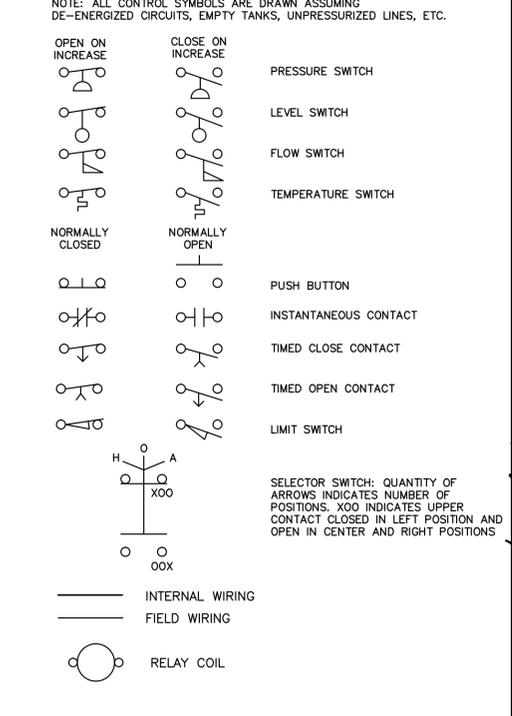

ABBREVIATIONS

A, AMP	AMPERES
AC	ALTERNATING CURRENT
AFF	ABOVE FINISHED FLOOR
AFG	ABOVE FINISHED GRADE
AHJ	AUTHORITY HAVING JURISDICTION
AIC	AMPERE INTERRUPT CAPACITY
AWG	AMERICAN WIRE GAUGE
BFG	BELOW FINISHED GRADE
CATV	CABLE TELEVISION
CB	CIRCUIT BREAKER
CCTV	CLOSED CIRCUIT TELEVISION
CL	CENTER LINE
CKT	CIRCUIT
CP	CONTROL PANEL
CPT	CONTROL POWER TRANSFORMER
CT	CURRENT TRANSFORMER
CU	COPPER
E.C.	ELECTRICAL CONTRACTOR
EMT	ELECTRIC METALLIC TUBING
FAA	FIRE ALARM ANNUNCIATOR
FACP	FIRE ALARM CONTROL PANEL
FBO	FURNISHED BY OTHERS
FWE	FURNISHED WITH EQUIPMENT
G.C.	GENERAL CONTRACTOR
GEN	GENERATOR
GFCI	GROUND FAULT CIRCUIT INTERRUPTER
GND	GROUND
HP	HORSEPOWER
HZ	FREQUENCY IN CYCLES/SECOND
IG	ISOLATED GROUND
IMT	INTERMEDIATE METALLIC CONDUIT
JBOX	JUNCTION BOX
K	KILO
KCMIL	1000 CIRCULAR MILS
KVA	KILOVOLT AMPERE
KVAR	KILOVOLT AMPERE REACTIVE
KW	KILOWATT
KWH	KILOWATT HOUR
MCC	MOTOR CONTROL CENTER
MCB	MAIN CIRCUIT BREAKER
MFG	MANUFACTURER
MH	MANHOLE
MLO	MAIN LUGS ONLY
MTD	MOUNTED
MTR	MOTOR
MV	MEDIUM VOLTAGE
NC	NORMALLY CLOSED
NEC	NATIONAL ELECTRIC CODE
NEUT	NEUTRAL
NO	NORMALLY OPEN
OL	OVERLOAD ELEMENT
PF	POWER FACTOR
PH	PHASE
PRI	PRIMARY
PT	POTENTIAL TRANSFORMER
PVC	POLYVINYL CHLORIDE
RGS	RIGID STEEL CONDUIT
RTD	RESISTANCE TEMPERATURE DETECTOR
SS	SECONDARY
SS	STAINLESS STEEL
SV	SOLENOID VALVE
TEMP	TEMPERATURE
TVSS	TRANSIENT VOLTAGE SURGE SUPPRESSOR
TYP	TYPICAL
UE	UNDERGROUND ELECTRIC
UG	UNDERGROUND
UPS	UNINTERRUPTED POWER SUPPLY
V	VOLTS
VA	VOLT-AMPERES
VAR	VOLT-AMPERE REACTIVE
W	WATT
WM	WATT METER
WP	WEATHER PROOF
XFMR	TRANSFORMER
XP	EXPLOSION PROOF

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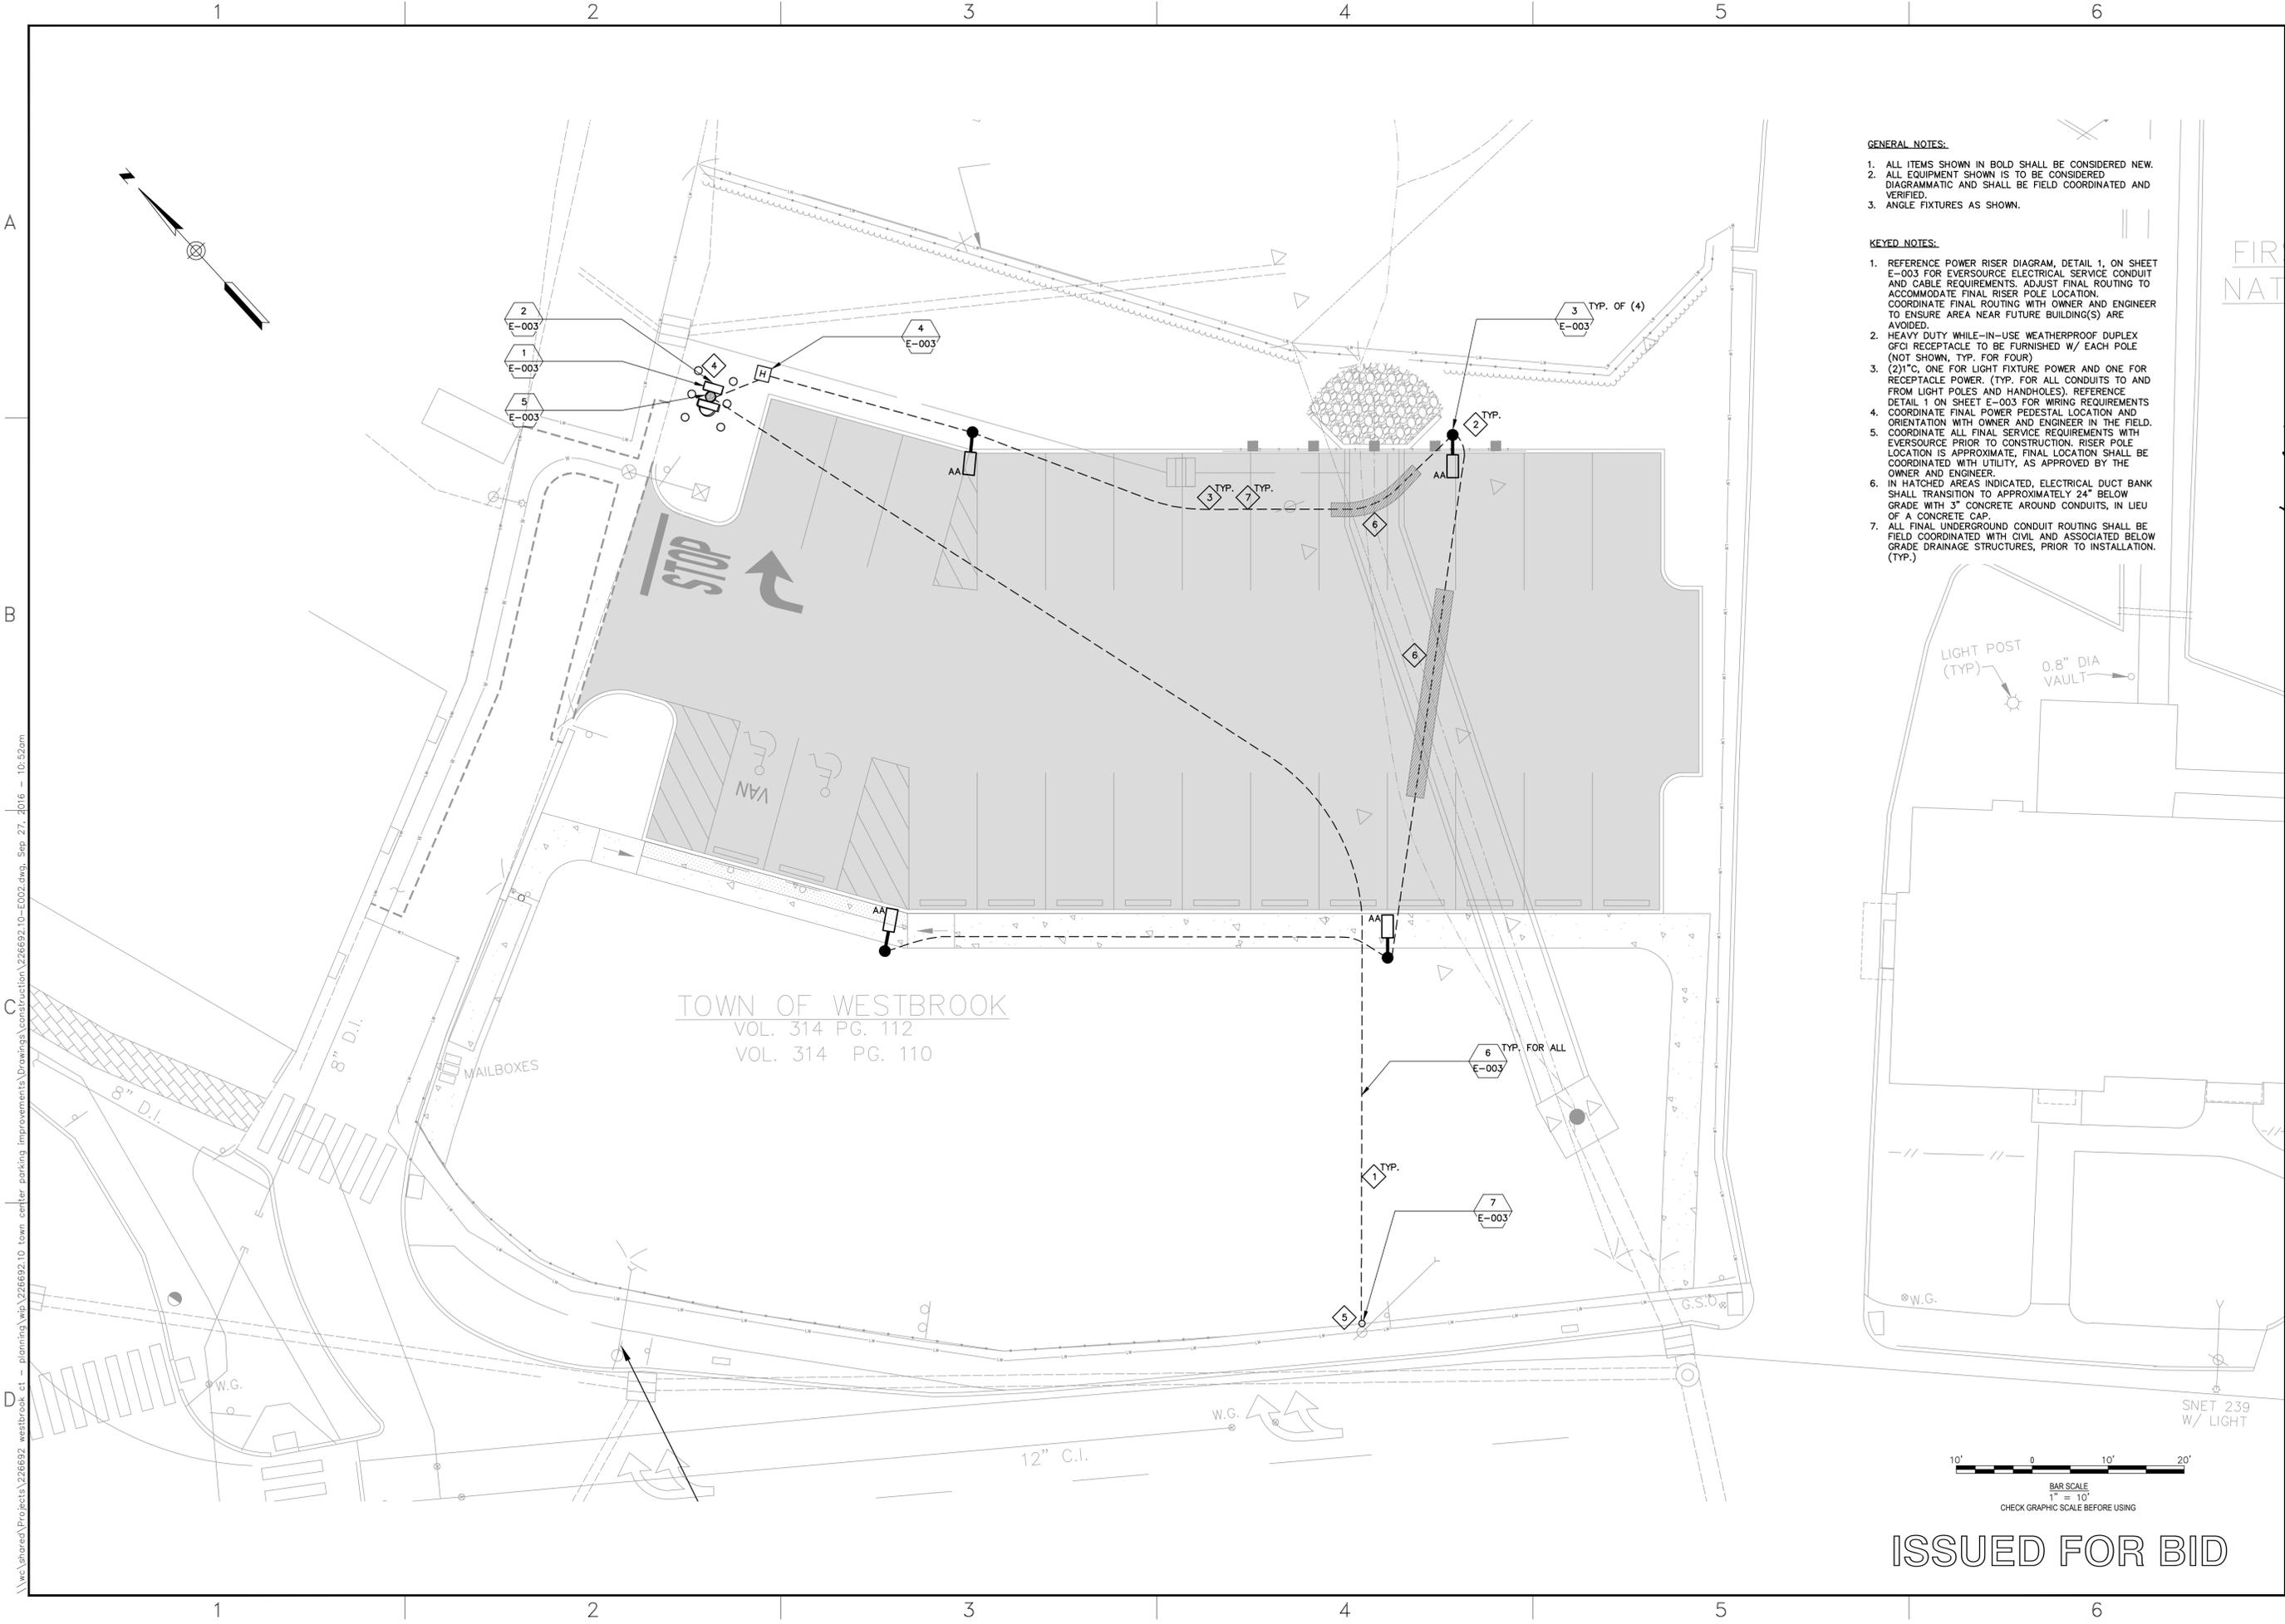
DESIGNED BY: SEH
CHECKED BY: A.J.F.
DRAWN BY: SEH
DATE: 2/26/2016

TOWN OF WESTBROOK, CT
TOWN CENTER PARKING IMPROVEMENT PLAN

JOB NO.: 226692.10
DATE: SEPTEMBER 28, 2016
SCALE: AS NOTED
SHEET: 10 OF 12



E-001

ISSUED FOR BID



- GENERAL NOTES:**
1. ALL ITEMS SHOWN IN BOLD SHALL BE CONSIDERED NEW.
 2. ALL EQUIPMENT SHOWN IS TO BE CONSIDERED DIAGRAMMATIC AND SHALL BE FIELD COORDINATED AND VERIFIED.
 3. ANGLE FIXTURES AS SHOWN.

- KEYED NOTES:**
1. REFERENCE POWER RISER DIAGRAM, DETAIL 1, ON SHEET E-003 FOR EVERSOURCE ELECTRICAL SERVICE CONDUIT AND CABLE REQUIREMENTS. ADJUST FINAL ROUTING TO ACCOMMODATE FINAL RISER POLE LOCATION. COORDINATE FINAL ROUTING WITH OWNER AND ENGINEER TO ENSURE AREA NEAR FUTURE BUILDING(S) ARE AVOIDED.
 2. HEAVY DUTY WHILE-IN-USE WEATHERPROOF DUPLEX GFI RECEPTACLE TO BE FURNISHED W/ EACH POLE (NOT SHOWN, TYP. FOR FOUR)
 3. (2)1"Ø. ONE FOR LIGHT FIXTURE POWER AND ONE FOR RECEPTACLE POWER. (TYP. FOR ALL CONDUITS TO AND FROM LIGHT POLES AND HANDHOLES). REFERENCE DETAIL 1 ON SHEET E-003 FOR WIRING REQUIREMENTS
 4. COORDINATE FINAL POWER PEDESTAL LOCATION AND ORIENTATION WITH OWNER AND ENGINEER IN THE FIELD.
 5. COORDINATE ALL FINAL SERVICE REQUIREMENTS WITH EVERSOURCE PRIOR TO CONSTRUCTION. RISER POLE LOCATION IS APPROXIMATE. FINAL LOCATION SHALL BE COORDINATED WITH UTILITY, AS APPROVED BY THE OWNER AND ENGINEER.
 6. IN HATCHED AREAS INDICATED, ELECTRICAL DUCT BANK SHALL TRANSITION TO APPROXIMATELY 24" BELOW GRADE WITH 3" CONCRETE AROUND CONDUITS, IN LIEU OF A CONCRETE CAP.
 7. ALL FINAL UNDERGROUND CONDUIT ROUTING SHALL BE FIELD COORDINATED WITH CIVIL AND ASSOCIATED BELOW GRADE DRAINAGE STRUCTURES, PRIOR TO INSTALLATION. (TYP.)

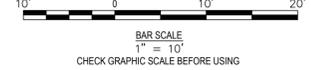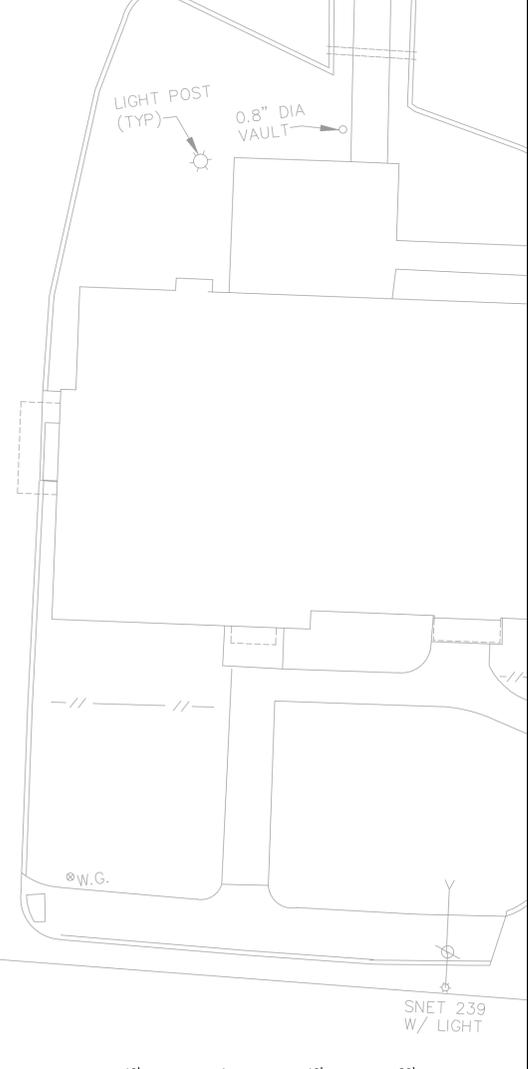

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REGISTERED PROFESSIONAL ENGINEER
 STATE OF CONNECTICUT
 ANDREW J. FITZPATRICK
 No. 0028004
 PROFESSIONAL LICENSE FOR ELECTRICAL ENGINEERING
 REPRODUCTION OR MODIFICATION WITHOUT WRITTEN PERMISSION IS PROHIBITED.

REV	DESCRIPTION	DATE

CHECKED BY: A.J.F.
 2/26/2016-10:50:00 AM

DESIGNED BY: SEH
 DRAWN BY: SEH

ELECTRICAL SITE PLAN


TOWN OF WESTBROOK, CT

TOWN CENTER PARKING
 IMPROVEMENT PLAN


JOB NO.: 226692.10
 DATE: SEPTEMBER 28, 2016
 SCALE: AS NOTED
 SHEET: 11 OF 12

E-002


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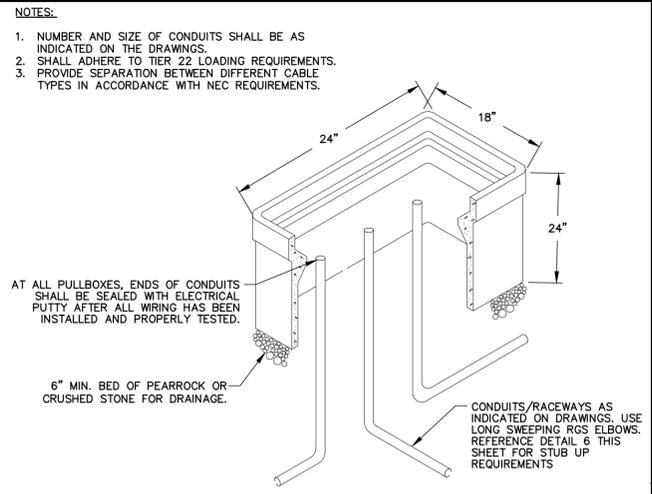
1 POWER RISER DIAGRAM
E-002 SCALE: NO SCALE

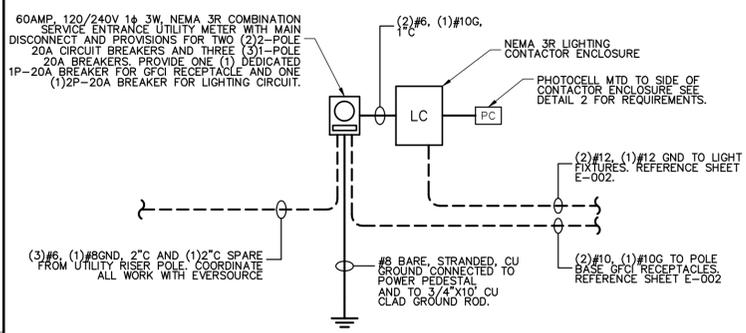


2 LIGHTING CONTROL WIRING DIAGRAM
E-002 SCALE: NO SCALE

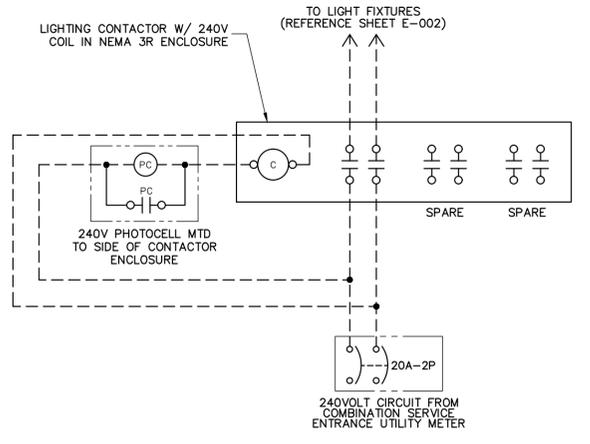


3 LIGHT POLE BASE DETAIL
E-002 SCALE: NO SCALE

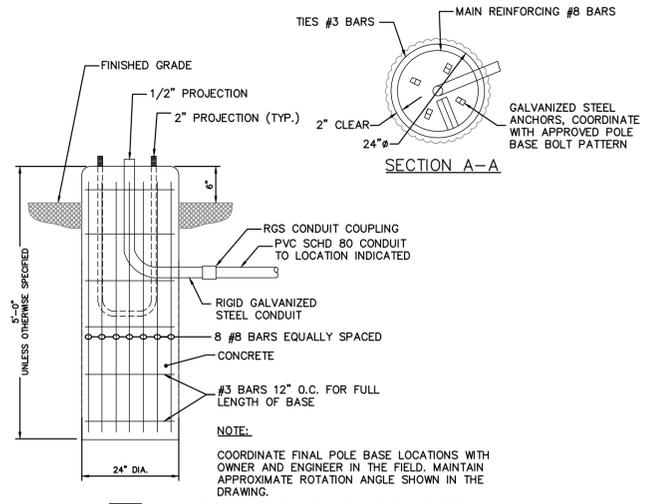


4 ELECTRICAL HANDHOLE DETAIL
E-002 SCALE: N.T.S.

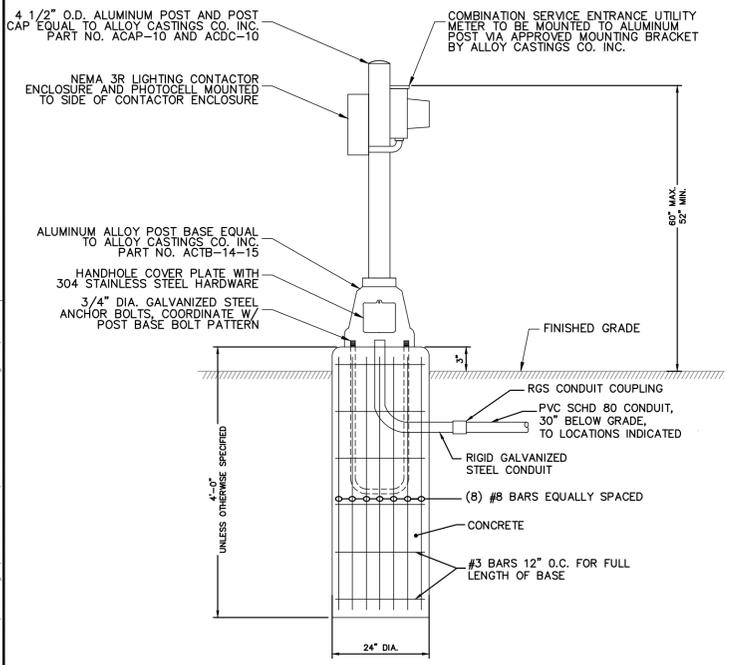

5 POWER PEDESTAL DETAIL
E-002 SCALE: NO SCALE

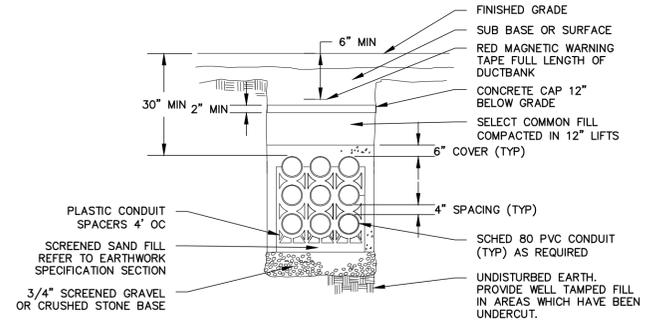

6 TYPICAL SAND ENCASED/CONCRETE CAPPED UNDERGROUND DUCT BANK DETAIL
E-002 SCALE: NO SCALE

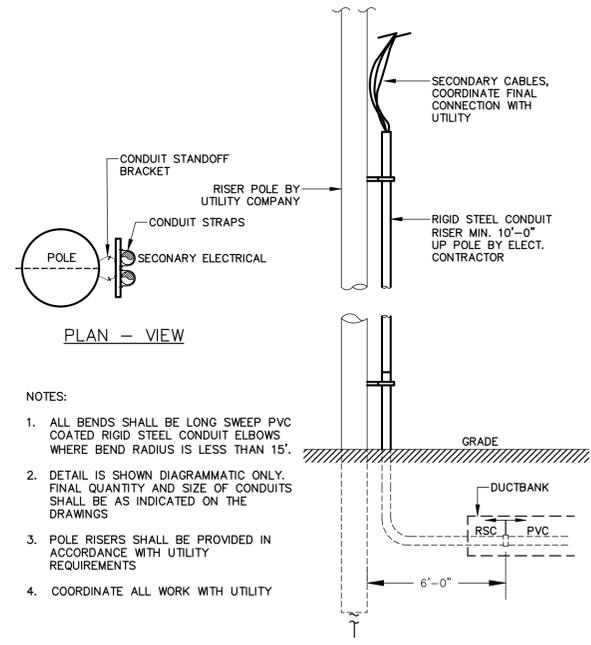

7 RISER POLE DETAIL
E-002 SCALE: NO SCALE

LIGHT FIXTURE SCHEDULE								
ALL FIXTURES SHALL BE FURNISHED COMPLETE WITH ALL HARDWARE, LAMPS, HANGERS, FITTINGS, ETC., FOR A COMPLETE AND PROPER INSTALLATION.								
TYPE	MANUFACTURER	CATALOG NUMBER	LAMP TYPE	LAMP WATT	LAMP NO.	VOLTAGE	MTG.	REMARKS/RECOMMENDATIONS
AA	PHILIPS-LUMEC DOMUS SMALL LUMINAIRE	FIXTURE: DOS-60W30LED-ES-LE4F-240 W/ DBA MOUNTING POLE: LUMEC TRADITIONAL ALUMINUM, TYPE RAB04F-14	LED	60W	30 LED	240V	POLE MOUNTED	1. FURNISH LIGHT POLE WITH INTEGRAL GFCI RECEPTABLES 2. POLE SHALL BE 14'-0" HEIGHT, 4" DIAMETER, STRAIGHT EXTRUDED ALUMINUM. 3. FIXTURE AND POLE FINISH COLOR: BLACK. 4. MAINTAIN APPROXIMATE ROTATION ANGLE SHOWN ON E002.

LIGHT FIXTURE SCHEDULE
SCALE: NOT TO SCALE

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REGISTERED PROFESSIONAL ENGINEER
No. 0028004
DESIGNED BY: SEH
DRAWN BY: SEH
CHECKED BY: A.J.F.
2/26/2016-10:50:00 AM

REV	DESCRIPTION	DATE

**ELECTRICAL LIGHTING,
POWER PLAN, DETAILS,
AND SCHEDULE**

TOWN OF WESTBROOK, CT

TOWN CENTER PARKING
IMPROVEMENT PLAN

JOB NO.: 226692.10
DATE: SEPTEMBER 28, 2016
SCALE: AS NOTED
SHEET: 12 OF 12

E-003

ISSUED FOR BID